

CPED STAFF REPORT

Prepared for the City Planning Commission CPC Agenda Item #10 November 16, 2020 PLAN11756

LAND USE APPLICATION SUMMARY

Property Location: 112 Lake Street East
Project Name: 112 Apartments

Prepared By: Andrew Frenz, Senior City Planner, (612) 673-3790

Applicant: James Tindall Jr.

Project Contact: Matt Borowy

Request: To construct a new four-story mixed-use building with 13 dwelling units and

approximately 1,600 square feet of commercial space.

Dwelling Units	13 dwelling units
Non-Residential Uses	Retail: 1,615 sq. ft.

Required Applications:

Variance	To reduce the minimum width of a drive aisle from 20 feet to three feet.
Variance	To increase the maximum permitted floor area ratio in the C2 Neighborhood Corridor Commercial District from 2.125 to 2.26.
Site Plan Review	For a new four-story mixed-use building with 13 dwelling units and approximately 1,600 square feet of commercial space.

SITE DATA

Existing Zoning	C2 Neighborhood Corridor Commercial District PO Pedestrian Oriented Overlay District			
Lot Area	5,437 square feet			
Ward(s)	10			
Neighborhood(s)	Whittier; adjacent to Lyndale			
Future Land Use	Community Mixed Use			
Goods and Services Corridor	Lake Street East			
Built Form	Transit 15			

Date Application Deemed Complete	October 21, 2020	Date Extension Letter Sent	
End of 60-Day Decision Period	December 20, 2020	End of 120-Day Decision Period	


BACKGROUND

SITE DESCRIPTION AND PRESENT USE. The subject property is a small parcel of 5,437 square feet in area and 44 feet in width. Public alleys are present adjacent to both the north and east.

The property was previously occupied by a single-story commercial building which contained approximately 1,800 square feet of retail space and was most recently occupied by a tobacco shop. This building was destroyed by arson in the unrest of May 2020.

SURROUNDING PROPERTIES AND NEIGHBORHOOD. The adjacent property to the west, 106 Lake Street East, was also occupied by a single-story retail building which was destroyed by arson in the unrest of May 2020. The next property to the west, 102 Lake Street East, was occupied by a single-story office building which was similarly destroyed. Across the public alleys to both the north and east of the site is a large property occupied by a medium industrial use (metal finishing and plating). The portion of this property located east of the subject property is utilized for surface parking, while the portion to the north is occupied by a large two-story industrial building.

Two major focal points of the immediate area are located in close proximity to the subject property: the former K-Mart redevelopment site located half a block to the west, and the new, under-construction Lake Street/35W Transit Center on the under-construction METRO Orange Line BRT located a half block to the east. The surrounding area contains a wide variety of uses. The immediate area along Lake Street is developed primarily with commercial uses and contains a high concentration of significant retail and commercial services uses. The larger surrounding area is developed primarily with a mix of commercial and mixed-use buildings on Lake Street and Nicollet Avenue, while the neighborhood interiors off of these corridors are developed primarily with residential uses which range from low- to very high-density, though institutional uses are also present.

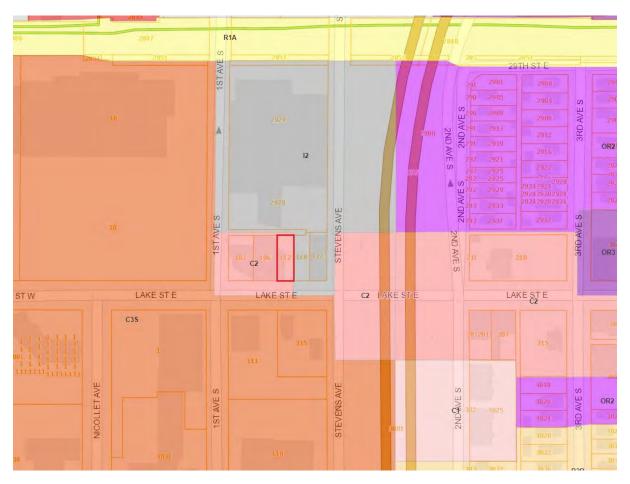

PROJECT DESCRIPTION. The applicant is proposing to construct a new four-story mixed-use building with 13 dwelling units and approximately 1,600 square feet of commercial space.

The applicant is proposing four surface parking stalls located to the rear of the building, accessed via the public alleys located adjacent to the north and east of the property. Vehicle maneuvering for parking serving commercial buildings and residential buildings with more than four units is required to be accommodated on-site, out of the public right-of-way. The applicant is proposing to provide three feet of maneuvering area between the proposed parking spaces and the alley, less than the 20-foot minimum drive aisle width and requiring maneuvering in the alley. The applicant is seeking a variance to reduce the minimum drive aisle width to allow the parking layout as proposed.

The proposed building would have a floor area ratio (FAR) of 2.26. The regular maximum FAR in the C2 District is 1.7, the project qualifies for a mixed-use density bonus which increases the maximum FAR to 2.125. The applicant is seeking a variance to increase the maximum permitted FAR to allow the project as proposed.

The applicant is also seeking site plan review.

PUBLIC COMMENTS. A letter from the neighborhood group regarding the project has been received and is attached to this report. Any additional correspondence received prior to the public meeting will be forwarded on to the Planning Commission for consideration.

ANALYSIS

VARIANCE

The Department of Community Planning and Economic Development has analyzed the application for a variance to reduce the minimum width of a drive aisle from 20 feet to three feet based on the following findings:

- 1. Practical difficulties exist in complying with the ordinance because of circumstances unique to the property. The unique circumstances were not created by persons presently having an interest in the property and are not based on economic considerations alone.
 - Practical difficulties exist in complying with the ordinance due to circumstances unique to the property. The subject property is a very small lot for a mixed-use development at only 5,437 square feet in area and 44 feet in width. Providing a full-width drive aisle on a property of this size would occupy an unreasonable proportion of the property purely for vehicular maneuvering and create difficulties in meeting other requirements such as minimum development intensity and minimum landscaped area requirements.
- 2. The property owner or authorized applicant proposes to use the property in a reasonable manner that will be in keeping with the spirit and intent of the ordinance and the comprehensive plan.
 - The proposed variance is reasonable and would in in keeping with the spirit and intent of the ordinance and comprehensive plan. Parking and loading regulations are established to recognize the parking and loading needs of uses and structures, to enhance the compatibility between parking and loading areas and their surroundings, and to regulate the number, design, maintenance, use and location of off-street parking and loading spaces and the driveways and aisles that provide access to maneuvering space. The proposed parking area would include four vehicle parking spaces. While serving a mixed-use building, the intensity of the traffic utilizing the parking area would be more similar to a much smaller development due to the small size of the lot. In addition, the alley located to the east of the property, which would be utilized to access two of the proposed parking spaces, is significantly wider than the typical alley in Minneapolis at 33 feet.

3. The proposed variance will not alter the essential character of the locality or be injurious to the use or enjoyment of other property in the vicinity. If granted, the proposed variance will not be detrimental to the health, safety, or welfare of the general public or of those utilizing the property or nearby properties.

The proposed variance will not alter the character of the immediate area and would not have an impact of the use or enjoyment of nearby property. The alleys in question are utilized for access to commercial properties and are not of a traditional residential character. The previous building on this property included approximately 14 parking stalls which were accessed via the alley located on the east side of the property and did not include a drive aisle to provide on-site maneuvering space. The proposed condition would be consistent with other properties in the area, including the former building on the subject property. While vehicles backing out of parking spaces into a public alley is not an ideal condition, it is a common condition throughout Minneapolis and the level of traffic associated with the proposed four-space parking area should not have an appreciable impact on the use or safety of the adjacent alleys.

VARIANCE

The Department of Community Planning and Economic Development has analyzed the application for a variance to increase the maximum permitted floor area ratio in the C2 Neighborhood Corridor Commercial District from 2.125 to 2.26 based on the following findings:

- 1. Practical difficulties exist in complying with the ordinance because of circumstances unique to the property. The unique circumstances were not created by persons presently having an interest in the property and are not based on economic considerations alone.
 - Practical difficulties exist in complying with the ordinance due to circumstances unique to the property. This proposed project comes at a unique time for this property, where the property is now subject to a minimum development intensity in the comprehensive plan, guiding the site for a minimum building height of four stories, however, the applicable bulk regulations for the property have not yet been updated. Complying with both the minimum height requirement contained in the comprehensive plan and the maximum FAR in the zoning code would be difficult and would unreasonably limit development options for the property.
- 2. The property owner or authorized applicant proposes to use the property in a reasonable manner that will be in keeping with the spirit and intent of the ordinance and the comprehensive plan.
 - The proposed variance is reasonable and would be in keeping with the spirit and intent of the ordinance and the comprehensive plan. The comprehensive plan guides this property for buildings of between four and ten stories in height. The existing maximum FAR is not consistent with this guidance. It is anticipated that in January 2021, the maximum FAR for this property will be increased significantly to implement the guidance from the comprehensive plan. Granting the proposed variance would be in keeping with the comprehensive plan and the changes being planned for the zoning code.
- 3. The proposed variance will not alter the essential character of the locality or be injurious to the use or enjoyment of other property in the vicinity. If granted, the proposed variance will not be detrimental to the health, safety, or welfare of the general public or of those utilizing the property or nearby properties.
 - The proposed variance would not alter the character of the area and would not be injurious to the use or enjoyment of nearby properties. The minor increase in FAR would allow a development more consistent with the anticipated direction of development in the area and would have no negative impacts on nearby properties or on public health or safety.

SITE PLAN REVIEW

The Department of Community Planning and Economic Development has analyzed the application based on the required <u>findings</u> and <u>applicable standards</u> in the site plan review chapter:

Applicable Standards of Chapter 530, Site Plan Review

BUILDING PLACEMENT AND DESIGN

Building placement – *Meets requirements*

The proposed project would comply with the building placement standards.

Principal entrances – *Meets requirements*

The proposed project would comply with the principal entrances standards.

Visual interest – *Requires alternative compliance*

- The proposed project would not comply with the visual interest standards.
- The building walls provide architectural detail and contain windows in order to create visual interest. While the south elevation does comply with all applicable standards for visual interest, building materials, and window requirements, staff does have some concerns regarding the south elevation appearing too "flat" due to limited articulation. Staff is recommending as a condition of approval that an awning or canopy be added to the south elevation above the retail storefront. Staff has discussed this condition with the applicant and they have indicated that they are amenable to the proposed condition.
- The building would include blank, uninterrupted walls exceeding 25 feet in length on the west elevation.
 Alternative compliance is required. On the east elevation, recesses are proposed to break up blank walls,
 however, the submitted plans do not clearly indicate the depth of the proposed recesses. Staff has
 recommended as a condition of approval that the proposed brick recesses have a minimum depth of at least
 two inches to eliminate blank walls.

Exterior materials – *Meets requirements*

- The applicant is proposing metal panels, brick, and fiber cement panels as the building's primary exterior materials. Exterior material changes at a later date may require review by the Planning Commission and an amendment to the site plan review.
- Each elevation would comply with the City's durability standards for exterior materials.
- The application is consistent with the City's policy of allowing no more than three exterior materials per elevation, excluding windows, doors, and foundation materials.
- The exterior materials and appearance of the rear and side walls of the building are similar to and compatible with the front of the building.

Percentage of Exterior Materials per Elevation

Material	Allowed Max	North	South	East	West
Brick	100%	21.2%	14.6%	25.2%	24.6%
Glass	100%	9.8%	19.1%	5.5%	0%
Metal Panel	75%	68.1%	64.9%	68.5%	45.2%
Fiber Cement (≤ 5/8")	30%	0%	0%	0%	29.4%

Windows – Requires alternative compliance

• The proposed project would not comply with the minimum window requirements.

- For residential uses, the zoning code requires that no less than 20 percent of the walls on the first floor, and
 no less than ten percent of the walls on each floor above the first that face a public street, public sidewalk,
 public pathway, or on-site parking lot, shall be windows. The project is in compliance with the minimum
 window requirement for the upper floors on both the north and south elevations, however, the project
 would not be in compliance with the minimum window requirement for residential uses on the first-floor
 north elevation. Alternative compliance is required.
- For nonresidential uses, the zoning code requires that no less than 30 percent of the walls on the first floor
 are windows with clear or lightly tinted glass with a visible light transmittance ratio of six-tenths (0.6) or
 higher. In addition, at least 40 percent of the first floor façade of a nonresidential use facing a public street
 or sidewalk is required to be windows or doors with clear or tinted glass in the Pedestrian Oriented Overlay
 District. The project is in compliance with the minimum window requirement.

Window Requirements for Residential Uses

Floor	Code		Proposed		
1st floor (north)	20% minimum	70 sq. ft.	12.1%	42.5 sq. ft.	
2nd floor and above (north)	10% minimum	135 sq. ft.	11.4%	153.7 sq. ft.	
2nd floor and above (south)	10% minimum	135 sq. ft.	17.9%	241.6 sq. ft.	

Window Requirements for Non-Residential Uses

Floor	Code		Proposed		
1st floor (south)	40% minimum	140.2 sq. ft.	49.7%	174.2 sq. ft.	

Ground floor active functions – *Meets requirements*

The proposed project would comply with the ground floor active functions requirements.

Roof line – *Meets requirements*

The principal roof line of the building would be similar to that of surrounding buildings.

Parking garages – Not applicable

• There are no parking garages proposed as part of this project.

Pedestrian access – *Meets requirements*

• There would be clear and well-lit walkways at least four feet in width connecting building entrances to the adjacent public sidewalk and on-site parking facilities.

Transit access – *Meets requirements*

• No transit shelters are proposed as part of this development.

Vehicular access – *Requires variance(s)*

- The proposed project would not comply with the vehicular access requirements. The applicant is proposing
 four parking spaces located to the rear of the building which require maneuvering in the public right-of-way.
 The applicant has applied for a variance to reduce the minimum width of a drive aisle to allow the proposed
 condition.
- Vehicular access and circulation has been designed to minimize conflicts with pedestrian traffic.

LANDSCAPING AND SCREENING

General landscaping and screening – *Meets requirements*

The proposed project would comply with the general landscaping and screening requirements.

Landscaping and Screening Requirements

Requirement	Required	Proposed
Lot Area		5,437 sq. ft.
Building Footprint		3,158 sq. ft.
Area Not Covered by Buildings		2,279 sq. ft.
Landscaped Area	456 sq. ft.	464 sq. ft.
Canopy Trees (1:500 sq. ft.)	1 tree	1 tree
Shrubs (1:100 sq. ft.)	5 shrubs	6 shrubs

Parking and loading landscaping and screening - Meets requirements

 The proposed project would comply with the applicable parking and loading landscaping and screening requirements.

Additional landscaping requirements – Meets requirements

- The project appears to comply with the additional landscaping requirements in sections 530.180, 530.190, 530.200, and 530.210 of the zoning code.
- The plant materials, and installation and maintenance of the plant materials, would comply with sections 530.200 and 530.210 of the zoning code.

ADDITIONAL STANDARDS

Concrete curbs and wheel stops – *Meets requirements*

• All parking lots and driveways are designed with wheel stops or discontinuous curbing to provide on-site retention and filtration of stormwater.

Site context – *Meets requirements*

• The proposed project would comply with the site context requirements.

Crime prevention through environmental design – *Meets requirements*

- The proposed project would comply with crime prevention through environmental design (CPTED) standards.
- The project provides lighting on site, at all building entrances, and along walkways that maintains a minimum acceptable level of security while not creating glare or excessive lighting of the site.

Historic preservation – *Meets requirements*

• This site is neither historically designated or located in a designated historic district, nor has it been determined to be eligible for designation.

Applicable Regulations of the Zoning Ordinance

The proposed use is permitted in the C2 District.

Off-street Parking and Loading – *Meets requirements*

- The proposed project complies with the applicable vehicle parking, bicycle parking, and loading requirements.
- No vehicle parking is required. The applicant is proposing to provide four vehicle parking stalls to the rear of the building.
- Three short-term bike parking stalls are required for the retail use and seven long-term bicycle parking stalls
 are required for the residential use. The applicant is proposing to provide 13 enclosed bicycle parking stalls
 for the residential uses, as well as four short-term bicycle parking stalls to the rear of the building near the
 residential entrance. Four additional short-term bicycle parking stalls will also be installed in the public rightof-way in front of the building as part of the in-progress reconstruction of this section of Lake Street East.
- The proposed uses do not have an off-street loading requirement.

Vehicle Parking Requirements Per Use (Chapter 541)

Use	Minimum	Reductions	Minimum	Maximum	Proposed
General Retail Sales and Services	4	Hennepin, Lyndale, Lagoon, and Lake area PO (4)	0	8	- 1
Residential Dwellings	13	Transit Incentives (13)	0		
			0		4

Bicycle Parking Requirements (Chapter 541)

Use	Minimum	Short-Term	Long-Term	Proposed
General Retail Sales and Services	3	Not less than 50%		4 short-term
Residential Dwellings	7		Not less than 90%	17 (4 short- term, 13 long- term)
	10			21 (8 short- term, 13 long- term)

Building Bulk and Height – *Requires variance(s)*

- The proposed project would not meet the applicable bulk and height requirements.
- The building would have an FAR of 2.26, exceeding the maximum permitted FAR of 2.125. The applicant is seeking a variance to increase the maximum FAR to allow the building as proposed.
- The proposed project would meet all other applicable bulk and height requirements.

Building Bulk and Height Requirements

Requirement	Code	Bonuses	Total	Proposed
Lot Area				5,437 sq. ft.

Gross Floor Area				12,242 sq. ft.
Min. Floor Area Ratio	1.0			2.26
Max. Floor Area Ratio	1.7	+0.425 for mixed commercial- residential	2.125	2.26
Max. Building Height	4 stories or 56 feet, whichever is less			4 stories, 51.7 ft.

Lot and Residential Unit Requirements – Meets requirements

- The proposed project would meet the applicable lot and residential unit requirements.
- The proposed dwelling units meet the minimum gross floor area requirement of 500 sq. ft. per unit or 350 sq. ft. per efficiency unit.
- The proposed project is not subject to inclusionary zoning requirements.

Yard Requirements – *Meets requirements*

• The property is not subject to any yard requirements.

Signs – *Meets requirements*

- All signs are subject to Chapter <u>543</u>, On-Premise Signs. The applicant will be required to submit a separate sign permit application for any signage that is proposed.
- The applicant is proposing a placeholder wall sign above the entrance to the retail space.

Signage Summary

Туре	Max. Size Allocation	Max. Area Per Sign	Proposed Area	Max. Height	Proposed Height
Attached	54.2 sq. ft.	180 sq. ft.	31 sq. ft.	34 ft.	13.3 ft.

Screening of Mechanical Equipment – *Meets requirements*

• Mechanical equipment is subject to the screening requirements of Chapter 535 and district requirements.

Refuse Screening – *Meets requirements*

• Refuse and recycling storage containers are subject to the screening requirements in Chapter 535.

Lighting – *Meets requirements*

- Existing and proposed lighting must comply with Chapter 531 and Chapter 541 of the zoning code.
- The project is consistent with the applicable lighting requirements.

Fences – Meets requirements

• Fences must comply with the requirements in Chapter 535. The proposed fencing meets the applicable standards. Apart from the proposed trash and recycling receptacle enclosure, no fencing is proposed as part of the project.

Specific Development Standards – *Meets requirements*

PO Pedestrian Oriented Overlay District Standards – *Meets requirements*

• The proposal is in compliance with the PO Pedestrian Oriented Overlay District standards.

Applicable Policies of the Comprehensive Plan

The proposed use would be consistent with the applicable guidance and policies of *Minneapolis 2040 (2020)*:

Future Land Use	Guidance	Staff Comment
Community Mixed Use	Large-scale mixed use development is encouraged throughout these areas, with commercial uses fronting on major streets. Commercial retail spaces are typically smaller in order to generate pedestrian activity, and are often a destination for customers coming from outside of the market area. Active uses that are accessible to the general public such as office, food service, retail, or medical establishments are required at the street level; therefore single-use residential development is not permitted. Contiguous expansion of commercial zoning is allowed.	The use of the property as a four- story mixed-use building with a ground-floor retail use fronting Lake Street East and dwelling units above would be consistent with the future land use guidance of Community Mixed Use.
Goods and Services Corridor	Guidance	Staff Comment
Lake Street East	Goods and Services Corridors serve two purposes: 1) To indicate where commercial uses should front in relation to properties guided for commercial future land uses, and 2) In addition to the guidance for the mixed use land use categories found in this section, Goods and Services Corridors identify where the establishment or expansion of commercial uses can be considered. Properties immediately adjacent to a Goods and Services Corridor may be considered for commercial activity, allowing for uses similar in scale and scope to the Neighborhood and Corridor Mixed Use categories.	The proposed retail use would front Lake Street East. Both the retail use and the residential use would include principal entrances facing Lake Street East. This is consistent with the guidance adjacent to a designated goods and services corridor.
Built Form	Guidance	Staff Comment
Transit 15	New and remodeled buildings in the Transit 15 district should reflect a variety of building types on both moderate and large	The use of the property as a four- story mixed-use building with a ground-floor retail use fronting

sized lots. Building heights should be 4 to	Lake Street East and dwelling units
15 stories. Building heights should be at	above would be consistent with
least 4 stories in order to best take	the built form guidance of Transit
advantage of the access to transit, jobs,	15.
and goods and services provided by the	
Transit 15 district. Requests to exceed 15	
stories will be evaluated on the basis of	
whether or not a taller building is a	
reasonable means for further achieving	
Comprehensive Plan goals.	

The following policies and action steps from Minneapolis 2040 (2020) apply to this proposal:

Policy 1. Access to Housing: Increase the supply of housing and its diversity of location and types.

- a. Allow housing to be built in all areas of the city, except in Production and Distribution areas.
- c. Allow multifamily housing on public transit routes, with higher densities along high-frequency routes and near METRO stations.

Policy 4. Access to Commercial Goods and Services: Improve access to goods and services via walking, biking and transit.

- a. Allow commercial uses where they currently exist throughout the city.
- d. Require commercial retail to be incorporated into new buildings in select areas of the city with the highest residential densities, highest pedestrian traffic, and most frequent transit service.
- e. Allow for increased housing supply within and adjacent to Commercial areas.

Policy 6. Pedestrian-Oriented Building and Site Design: Regulate land uses, building design, and site design of new development consistent with a transportation system that prioritizes walking first, following by bicycling and transit use, and lastly motor vehicle use.

- b. Encourage multiple storefront bays with direct connections to the sidewalk where active or commercial ground floor uses are required.
- c. Require windows and window treatments on buildings that allow clear views into and out of the building.
- d. Ensure that buildings incorporate design elements that eliminate long stretches of blank, inactive exterior walls through provision of windows, multiple entrance doors, green walls, and architectural details.
- e. Integrate components in building designs that offer seasonal protection to pedestrians, such as awnings and canopies, to encourage pedestrian activity along the street.

Policy 80. Development Near METRO Stations: Support development and public realm improvements near existing and planned METRO stations that result in walkable districts for living, working, shopping, and recreating.

- a. Allow and encourage a dense mix of housing, employment, and commercial goods and services near METRO stations.
- Require a minimum level of development near METRO stations to ensure that land is used efficiently near major transit investments.
- g. Orient buildings to the sidewalk.
- h. Focus active uses on the ground floor of buildings along main pedestrian routes leading to and facing METRO stations.

j. Minimize the impact of automobiles near METRO stations by locating parking behind and under buildings, by sharing parking among area uses, by prohibiting the establishment of auto-oriented uses, and by prohibiting the establishment of stand-alone dedicated park-and-ride facilities.

Alternative Compliance

The Planning Commission or zoning administrator may approve alternatives to any site plan review requirement upon finding that the project meets one of three criteria required for <u>alternative compliance</u>. Alternative compliance is requested for the following requirements:

Standard	Description	Staff Recommendation
Blank Walls	There are blank walls of 42.8 feet in length proposed for the second, third, and fourthfloor west elevation, greater than the maximum length of 25 feet for blank walls. The applicant is proposing to include a mural on this blank wall.	The proposed project would be constructed directly up to the west property line in anticipation of facilitating a party wall with a future redevelopment of the adjacent properties at 102 and 106 Lake Street East, which are both currently vacant after being destroyed by arson in the unrest of May 2020. While the west elevation will be prominently visible until these properties are redeveloped, it is anticipated that a redevelopment of these properties would greatly reduce the visibility of this elevation. Staff finds that the proposed mural would mitigate the impact of the proposed blank wall until the redevelopment of the adjacent properties occurs. Staff recommends granting alternative compliance.
Window Coverage	The building would include 12.1% window coverage on the first-floor north elevation, less than the minimum requirement of 20%.	The north elevation faces on-site parking and trash and recycling storage, and an industrial use across the alley. Beyond the window area included in the window coverage calculation, the applicant is proposing a total of three full-view glass doors. Given the additional glass area included in the doors that is not included in the window area calculation and the use of the space adjacent to the north elevation, staff finds the proposed alternative compliance

to be reasonable and meeting the intent of the ordinance. The
property also exceeds the
minimum window coverage
requirements on the upper levels
of the north elevation. <u>Staff</u>
recommends granting alternative
compliance.

RECOMMENDATIONS

The Department of Community Planning and Economic Development recommends that the City Planning Commission adopt staff findings for the applications by James Tindall Jr. for the property located at 112 Lake Street East:

A. Variance to reduce drive aisle width.

Recommended motion: <u>Approve</u> the variance to reduce the minimum width of a drive aisle from 20 feet to three feet.

B. Variance to increase maximum floor area ratio.

Recommended motion: <u>Approve</u> the variance to increase the maximum permitted floor area ratio in the C2 Neighborhood Corridor Commercial District from 2.125 to 2.26.

C. Site Plan Review.

Recommended motion: <u>Approve</u> the site plan review for a new four-story mixed-use building with 13 dwelling units and approximately 1,600 square feet of commercial space, subject to the following conditions:

- 1. All site improvements shall be completed by November 16, 2022, unless extended by the Zoning Administrator, or the permit may be revoked for non-compliance.
- 2. CPED staff shall review and approve the final site, elevation, landscaping, and lighting plans before building permits may be issued.
- 3. All signs shall comply with Chapter 543 of the zoning code. All signage requires a separate permit from CPED.
- 4. A canopy or awning shall be added above the retail storefront.
- 5. The proposed brick recesses on the east and west elevations shall have a minimum depth of at least two inches, in accordance with Section 530.120 of the zoning code.

ATTACHMENTS

- 1. Oblique aerial photo
- 2. Written description and findings submitted by applicant
- 3. Notification letters submitted by applicant
- 4. Survey
- 5. Plans
- 6. Renderings
- 7. Public Comments





In Partnership With



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Project Narrative 112 E. Lake Street

To: Andrew Frenz
From: Matt Borowy
Date: 10/22/2020

Re: Site Plan Review & Variance

Mr Frenz,

I want to thank you for the opportunity to submit the following project narrative for the proposed mixed-use development located at 112 East Lake Street in Minneapolis, MN.

Per our previous correspondence, my team's desire is to work closely with the city staff over the following weeks to carry out the review process. We would like to thank you for the support and patience that has been afforded to our team thus far. The project team requests approval of the building and site designs as specified in the attached drawings.

This project intends to replace a building that was burned down in the civil unrest of 2020. The design team is proposing a 4-story mixed-use building with primarily retail space on the first level with 3 levels of 1 bedroom apartments above. An accessible apartment will be provided on the first level. The total number of apartment units will be 13, and 5 parking stalls are planned for the site.

Design Direction

The design strategy is to provide a handsome addition to the neighborhood that is consistent with the existing urban scale and design languages. Our team has worked with intentionality to fuse existing design elements of the surrounding neighborhood with a current architectural dialect to produce a solution that is compatible with a neighborhood in transition.

The proposed materials are brick, metal panels, aluminum & glass, wood-look metal siding and metal trim. Historically-inspired brick pilasters have been incorporated into the east and west elevations on

the 1st level to provide surface articulation. Levels 2-4 blend alternating orientations of linear metal panels as well as accent inlays of wood-look siding that serves to organize the residential windows. The west elevation provides a large area to allow for a mural in lieu of windows openings. (see variance number 2 below and exterior elevations for more information).

Interior circulation has been designed with a focus on life-safety, access to exterior views and unit efficiency. We have identified the south elevation along Lake Street as the most prominent of the building and have located the south stair shaft accordingly. The traditional urban language of a zero lot line mixed-use building has been preserved with a symmetrical fenestration design and clear separation of uses between the retail and residential components. The north stair tower has been shifted north of the residential units to allow for ample separation between exit paths and to provide a semi-private courtyard on the north end of the property by using the stair shaft as a "wing wall".

The north stair location has been extensively studied, and this resourceful layout provides the best compromise between code-required items such as the minimum distance between exits and quality-of-life items such as natural light and views.

The north side of the building has also been denoted as the location for vehicular and bicycle parking as well as an electrical transformer and the trash enclosure. The designated enclosure is designed to accommodate a compost container as well as (2) 4 yard containers: one with trash and one with recycled materials. The area required for this operation has been denoted on sheets C2.0 and L1.0. The existing alleyways bordering the north and east property lines provide convenient access for recycling/trash vehicles and automobiles (see variance number 1 below for more information).

Sustainable Initiatives

Reduction of initial resources and ongoing utilities are important from both a cost containment standpoint and overall environmental stewardship. The design team has targeted several items that work toward that aim. Key sustainable items area as follows:

- 1) Mechanical system featuring high-efficiency units with individually controlled heating and cooling to reduce energy usage
- 2) Electrical system featuring LED lighting to reduce power usage
- 3) Plumbing system featuring low-flow fixtures to reduce water usage
- 4) Two sets of bike racks are suggested as noted on sheet L1.0 (the Lake Street Reconstruction project includes bike racks on the south area of the building as well) A secured interior bike room is provided with capacity for all tenants.
- 5) Maintenance free exterior materials that will reduce product waste and mobilization impacts over the lifetime of the building
- Exterior skin with upgraded R-value that will exceed the current energy code to reduce overall energy use for heating and cooling

Pedestrian Impact

The proposed development has been designed for efficient and safe pedestrian flow parallel to vehicular flow. Foot and bicycle traffic has been prioritized by providing access on both the north and south ends of the building for retail and residential tenants.

The design team understands that the city is currently undergoing an extensive Lake Street Reconstruction Project. The design engineering team has reviewed the location of these improvements and has located the building and site elements accordingly to ensure orderly integration with adjacent elements.

Variance

Findings:

- (1) Practical difficulties exist in complying with the ordinance because of circumstances unique to the property. The unique circumstances were not created by persons presently having an interest in the property and are not based on economic considerations alone.
- (2) The property owner or authorized applicant proposes to use the property in a reasonable manner that will be in keeping with the spirit and intent of the ordinance and the comprehensive plan.
- (3) The proposed variance will not alter the essential character of the locality or be injurious to the use or enjoyment of other property in the vicinity. If granted, the proposed variance will not be detrimental to the health, safety, or welfare of the general public or of those utilizing the property or nearby properties.

Variance number 1: Allow for maneuverability in north and east alleyways for parking access.

Response to finding 1)The project site is 40' wide. Previously the east 18' of the site was used for a row of parking stalls accessed by the existing alleyway. Per feedback from city staff, the building has been designed to include full width of the property along the south elevation facing Lake Street. The resulting space for parking is located to the north behind the building. The effect of this orientation is to hide the vehicular parking and help to separate vehicular traffic from foot traffic on the sidewalk. However, for this solution to work, vehicular circulation is dependent on the use of the alleyways.

Response to finding 2) The design team understands the ordinance is intended to ensure that the alleyways remain open and functional for vehicular, cycling and pedestrian traffic. A large, busy parking area that is reliant on maneuverability in the alleyways could impede flow and create a dangerous space. We feel that the proposed site plan with 5 stalls does not create a hazardous condition and actually reduces the load from the previous usage.

Response to finding 3) The essential character of the locality is set to be improved through acceptance of this variance. Street scape frontage is preserved, utilities are discretely hidden away, ada route is direct, and public & private entrances are separated.

Variance number 2: Request alternative compliance for mural panel on west elevation in lieu of window openings

Response to finding 1) The project site is currently zoned C2 which allows for 0' setbacks for developments. With an adjacent lot to the west, it is the owner's expectation that a 4-story building will be constructed that will fully-obscure the west elevation.

Response to finding 2) The design team understands the ordinance is intended to ensure that proposed developments do not focus design efforts on the "front" of the building while neglecting the

other elevations. Consistently spaced windows in an exterior wall can provide an appealing connection between building users and the wider neighborhood. A mural space has been proposed in the solid wall to provide visual interest as a substitute.

Response to finding 3) The proposed design incorporates primarily the same materials as the rest of the building to maintain visual consistency. Furthermore, a large mural has the potential to uplift the neighborhood and galvanize community spirit.

Alternative Compliance

Number 1: Request alternative compliance for first-floor north elevation window coverage requirements

The width of the building on the north elevation is 44' and contains three entrance points. Fenestration has been designed to maintain the rhythm of the upper floors of the building on the first level. Full-glass aluminum doors have been suggested in-lieu of windows to provide access to building and to comply with the spirit of the ordinance.

Number 2: Request for alternative compliance for maximum floor area ratio

This is a neighborhood in transition, and the current ordinance is not written for 4-15 story developments. The design team requests approval of floor area ratio per the updated ordinances that will be forthcoming.

Once again, thank you for this opportunity to submit this preliminary site/building plan package. If you have any questions regarding this submittal, please do not hesitate to call.

Sincerely,

Matt J. Borowy
Bright Pixel Design

507.720.1398

www.brightpixeldesign.com

Borowy

Mon, Sep 14, 12:36 PM



Matt Borowy <matt@brightpixeldesign.com> to brad, kaley, andrea.jenkins, lisa.bender *

Hello All,

I'm reaching out to introduce a proposal to replace a building that was lost in the civil unrest this summer.

The design team is planning a 4-story mixed use building with primarily retail space on the first level with 3 levels of 1 bedroom apartments above. An accessible apartment will be provided on the first level. The total number of apartment units will be 13. 7 parking stalls are planned for the site.

We will need a variance to allow for access to the parking stalls through the alleys. Please review the attached packet and get back to me with any feedback you have.

Thank You,

Matt J Borowy Bright Pixel Design

802 Lower Johnson Circle St. Peter, MN 56082 507.720.1398

www.brightpixeldesign.com





112 EAST LAKE STREET

MINNEAPOLIS, MINNESOTA
ISSUED FOR: PDR SUBMITTAL



ARCHITECT:

BRIGHTPIXEL DESIGN
802 LOWER JOHNSON CIR,
ST PETER, MN 56082
CONTACT: MATT BOROWY
MATT@BRIGHTPIXELDESIGN.COM
507-7201398

DEVELOPER / PROPERTY OWNER:

JWT LAKE ST, LLC 2400 BLAISDELL AVE MINNEAPOLIS, MN 55404

ENGINEER / LANDSCAPE ARCHITECT:

CIVIL SITE GROUP 4931 W 35TH STREET SUITE 200 ST LOUIS PARK, MN 55416 612-615-0060

SURVEYOR:

CIVIL SITE GROUP 4931 W 35TH STREET SUITE 200 ST LOUIS PARK, MN 55416 CONTACT: RORY SYNSTELIEN 612-615-0060

GEOTECHNICAL ENGINEER:

TBD

ALL EXISTING UTILITY LOCATIONS SHOWN ARE APPROXIMATE. CONTACT "GOPHER STATE ONE CALL" (651-454-0002 OR 800-252-1166) FOR UTILITY LOCATIONS, 48 HOURS PRIOR TO CONSTRUCTION. THE CONTRACTOR SHALL REPAIR OR REPLACE ANY UTILITIES THAT ARE DAMAGED DURING CONSTRUCTION AT NO COST TO THE OWNER.



DATE 11/02/20 LICENSE NO. 44263 ISSUE/SUBMITTAL SUMMARY DATE DESCRIPTION 10/08/2020 PDR SUBMITTAL 10/20/20 PDR SUBMITTAL 11/02/20 PDR SUBMITTAL SHEET INDEX SHEET NUMBER | SHEET TITLE C0.0 TITLE SHEET V1.0 SITE SURVEY C1.0 REMOVALS PLAN C2.0 SITE PLAN C3.0 GRADING PLAN C4.0 UTILITY PLAN C5.0 CIVIL DETAILS C5.1 CIVIL DETAILS L1.0 LANDSCAPE PLAN L1.1 LANDSCAPE PLAN NOTES & DETAILS DRAWN BY:KB, KW REVIEWED BY: MP SW1.0 SWPPP - EXISTING CONDITIONS PROJECT NUMBER: 20267 SW1.1 SWPPP - PROPOSED CONDITIONS **REVISION SUMMARY** SW1.2 | SWPPP - DETAILS DATE DESCRIPTION SW1.3 SWPPP - NARRATIVE TITLE SHEET

Civilsitegroup.com


612-615-0060

RECTANGED TO THE STANDARD TO

St. Louis Park, MN 55416

EAST LAKE STREET, MINNEAPOL

I HEREBY CERTIFY THAT THIS PLAN,
SPECIFICATION, OR REPORT WAS
PREPARED BY ME OR UNDER MY DIRECT
SUPERVISION AND THAT I AM A DULY
LICENSED PROFESSIONAL ENGINEER
UNDER THE LAWS OF THE STATE OF
MINNESOTA.

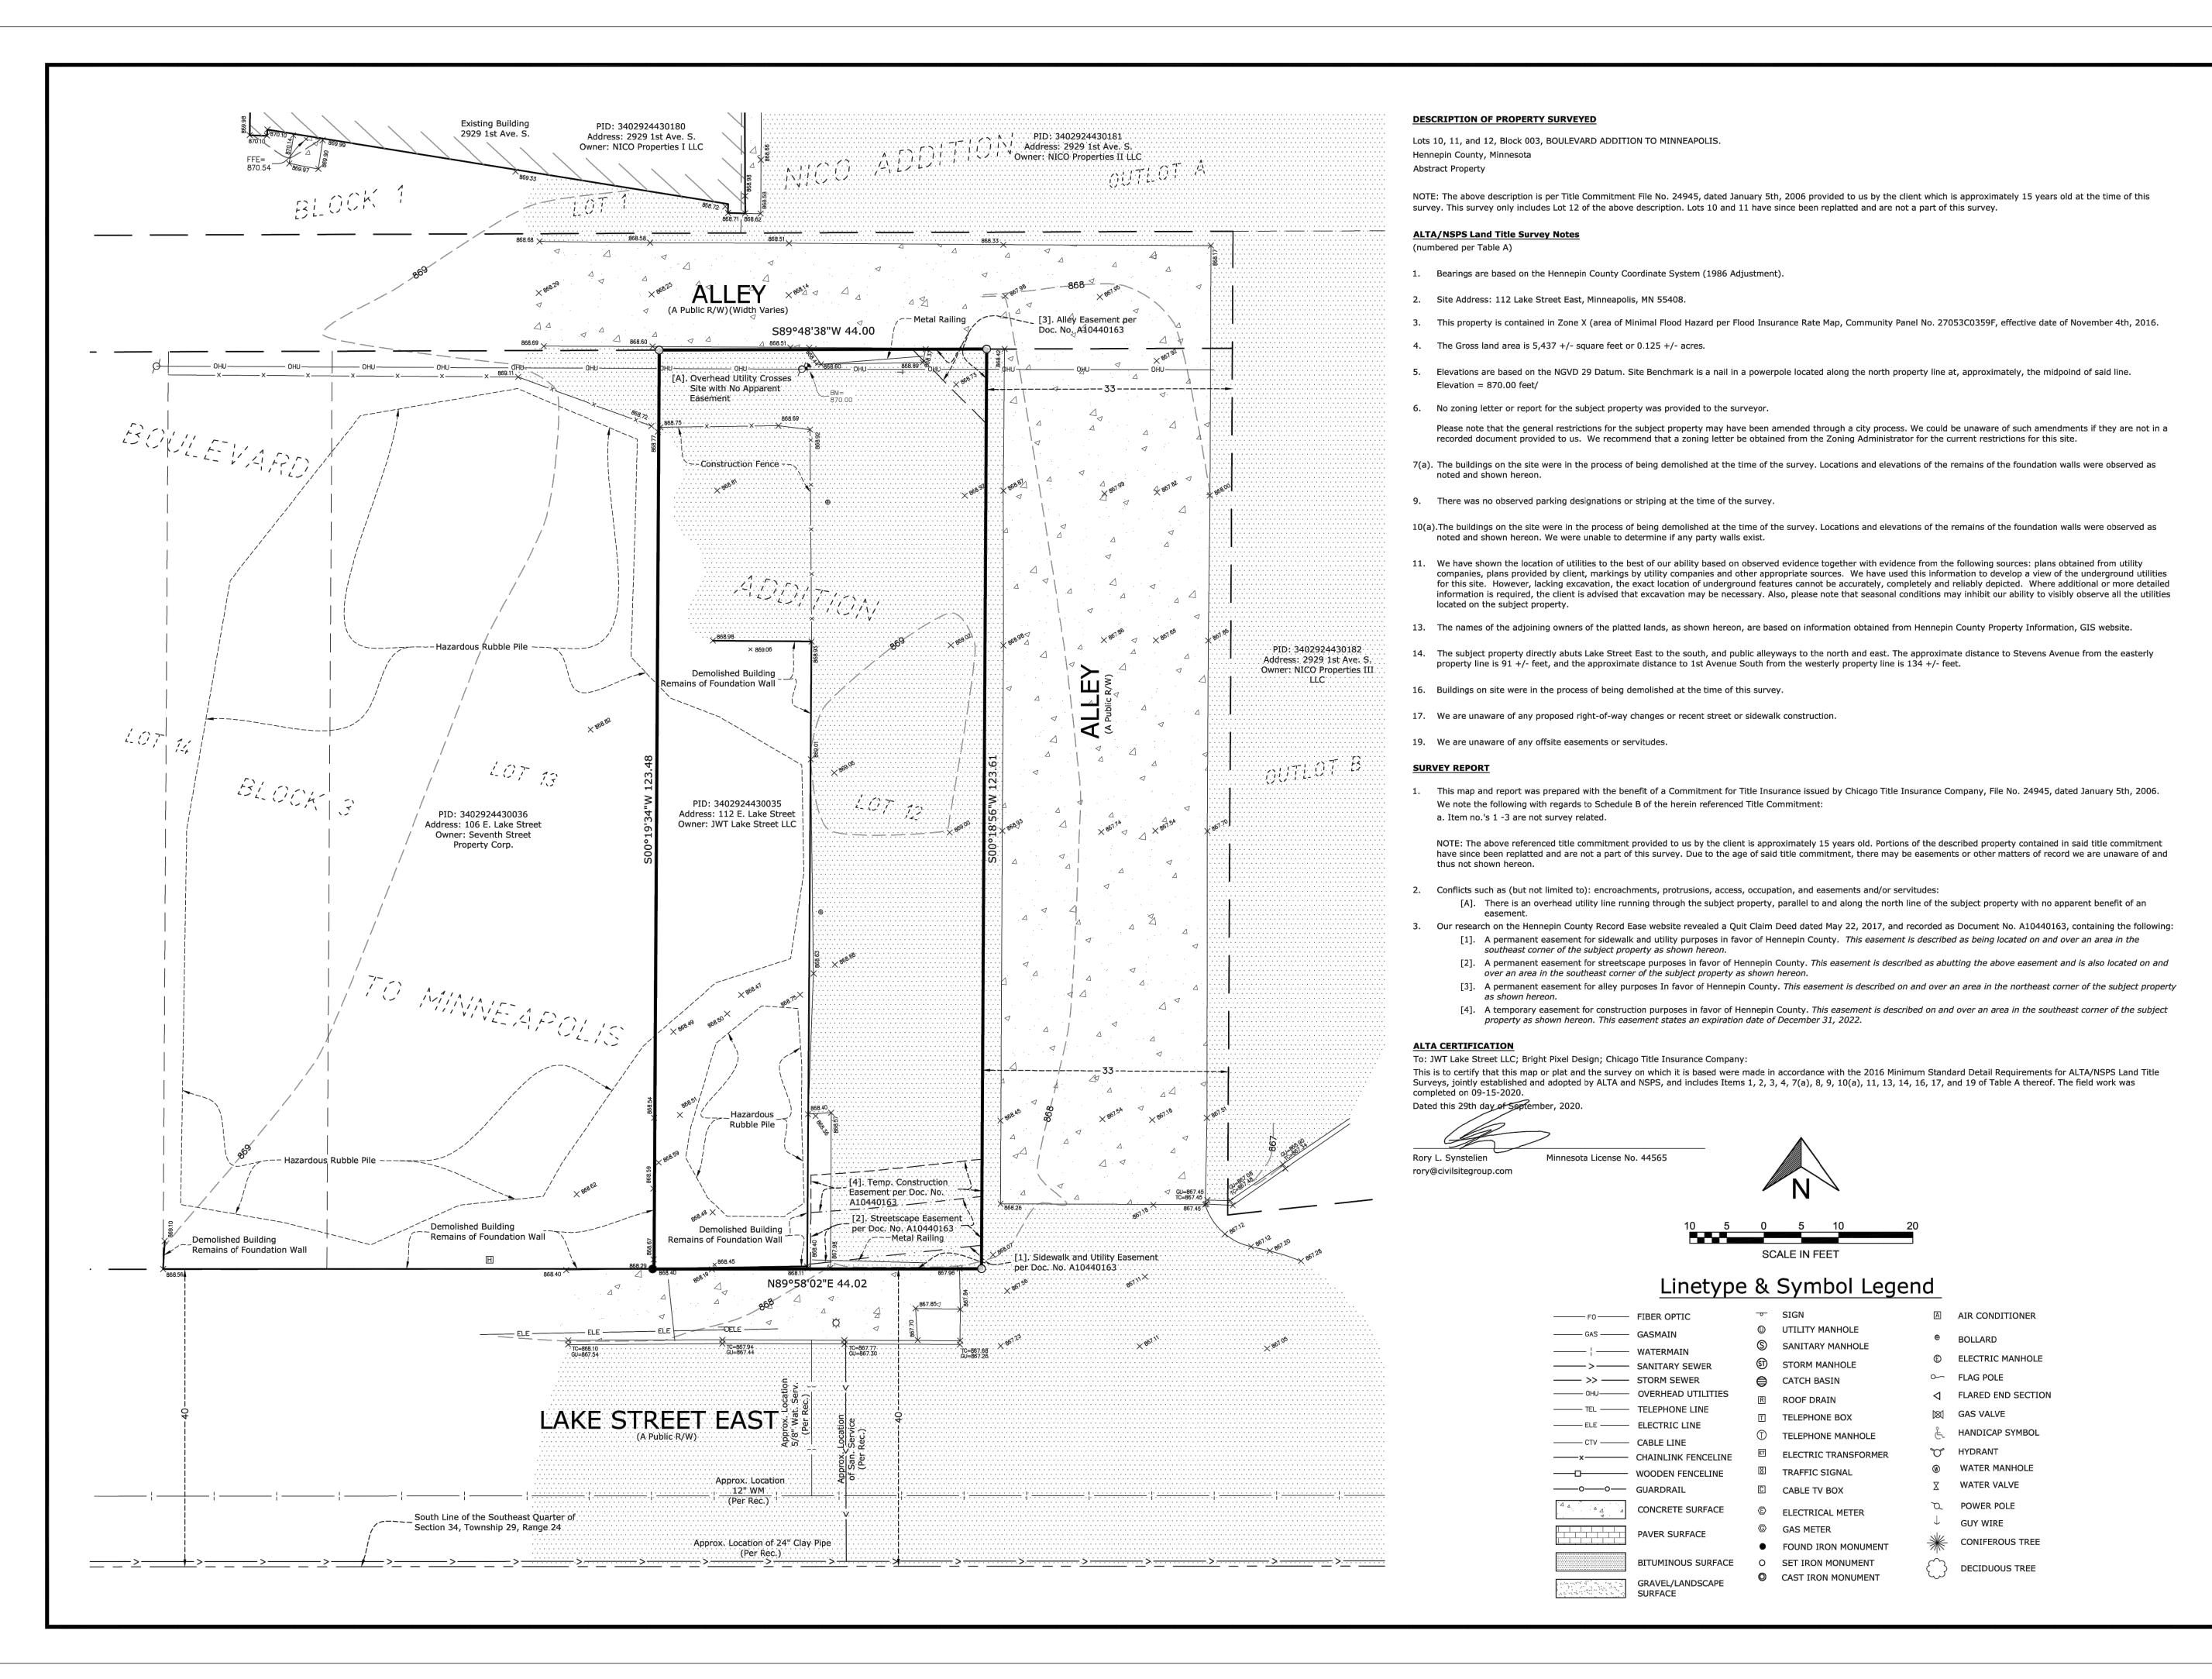

4931 W. 35th Street, Suite 200

St. Louis Park, MN 55416

vilsitegroup.com

612-615-0060

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Design Pixel $\mathbf{\Omega}$

I HEREBY CERTIFY THAT THIS SURVEY, PLAN, OR REPORT WAS PREPARED BY ME OR UNDER MY DIRECT SUPERVISION AND THAT I AM A DULY LICENSED LAND SURVEYOR UNDER THE LAWS OF THE STATE OF MINNESOTA.



QA/QC FIELD CREW MS/AS EVIEWED BY UPDATED BY

VICINITY MAP

REVISION SUMMARY


DATE DESCRIPTION

ALTA/NSPS LAND TITLE SURVEY

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MOVE EXISTING OVERHEAD WIRES, COORDINATE WITH UTILITY OWNER PRIOR TO CONSRTRUCTION	[A]. Overhead Utility Crosses Site with No Apparent Easement Construction Fence REMOVE EXISTING FENCE AND FOOTING, TYP.	014 014 014 014 014 014 014 014 014 014	CÖNSTRUCTION LIN 33 EXISTING AL REMAIN PER FROM DAMAGE	LEY TO - 80 100 OTECT + 86 100
Hazardous Rubble Pile	Demolished Building Remains of Foundation Wall REMOVE EXITING DEMOLISHED BUILDING REMAINS OF FOUNDATION WALL & FOOTINGS, TYP.	REMOVE EXISTING PAVEMENT AND BASE MATERIAL AND PARKING SIGNS, TYP.		86 ×861 65 × 861 86 PID: 3402924430182 Address: 2929 1st Ave. S, Owner: NICO Properties III.
PID: 3402924430036 Address: 106 E. Lake Street Owner: Seventh Street Property Corp.	RUBBLE PILE, TYP. PID: 3402924430035 Address: 112 E. Lake Street Owner: JWT Lake Street LLC		208018'56'W'123'61	SAW CUT ALONG OUTLOT B CONCRETE ALLEY
MINNEAPOLIS,	REMOVE EXISTING GUARD POST & FOOTING, TYP. REMOVE HAZARDOUS RUBBLE PILE, TYP. REMOVE EXITING DEMOLISHED BUILDING REMAINS OF FOUNDATION WALL & FOOTINGS, TYP.	BEMOVE EXISTINO		EXISTING ALLEY TO — REMAIN, PROTECT FROM DAMAGE, TYP
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UTILITY SERVICES PER UTILITY COMPANY AND CITY STANDARDS Demolished Building Remains of Foundaticonstruction Limits EXISTING SIDEWALK TO REMAIN, PROTECT FROM DAMAGE, TYP. REMOVE EXISTING	DEMONSHED BUILDING REMAINS OF FOUNDATION WALL & FOOTINGS, TYP Demolished Building Remains of Edundation Wall RAILING & FOOTINGS, TYP.	Easement per Doc. No. A10440163 [2]. Streetscape Easement per Doc. No. A10440163 — Metal Railing 2" A44.02; A 86.99	/ " / / / /	EX. EASEMENTS TO BE VACATED assement EXISTING SIDEWALK TO REMAIN, PROTECT
BACK TO M	A Public R/W)	Approx. Location of San. Service (Per Rec.)	87/168 867.26 - SALVAGE & RELOCATE EXISTING LIGHT POLE PER CITY STANDARDS, TYP. — ABANDON EXISTING SANITARY SEWER SERVICE PER MINNEAPOLIS STANDARDS	REMOVE EXISTING C&G, TYP.
outh Line of the Southeast Quarter of ection 34, Township 29, Range 24	Approx. Location 12" WM (Per Rec.) Approx. Location of 24" Clay P (Per Rec.)			

REMOVAL NOTES:

- ALL EXISTING UTILITY LOCATIONS SHOWN ARE APPROXIMATE. CONTACT "GOPHER STATE ONE CALL" (651-454-0002 OR 800-252-1166) FOR UTILITY LOCATIONS, 48 HOURS PRIOR TO CONSTRUCTION. THE CONTRACTOR SHALL REPAIR OR REPLACE ANY UTILITIES THAT ARE DAMAGED DURING CONSTRUCTION AT NO COST TO THE OWNER.
- SEE STORM WATER POLLUTION PREVENTION PLAN (SWPPP) PLAN FOR CONSTRUCTION STORM WATER MANAGEMENT PLAN.
- REMOVAL OF MATERIALS NOTED ON THE DRAWINGS SHALL BE IN ACCORDANCE WITH MNDOT, STATE AND LOCAL REGULATIONS.
- EMOVAL OF PRIVATE UTILITIES SHALL BE COORDINATED WITH UTILITY OWNER PRIOR TO CONSTRUCTION ACTIVITIES.
- EXISTING PAVEMENTS SHALL BE SAWCUT IN LOCATIONS AS SHOWN ON THE DRAWINGS OR THE NEAREST JOINT FOR PROPOSED PAVEMENT CONNECTIONS.
- REMOVED MATERIALS SHALL BE DISPOSED OF TO A LEGAL OFF-SITE LOCATION AND IN ACCORDANCE WITH STATE AND LOCAL REGULATIONS.
- BANDON, REMOVAL, CONNECTION, AND PROTECTION NOTES SHOWN ON THE DRAWINGS ARE APPROXIMATE. COORDINATE WITH PROPOSED PLANS.
- XISTING ON-SITE FEATURES NOT NOTED FOR REMOVAL SHALL BE PROTECTED THROUGHOUT THE DURATION OF THE CONTRACT.
- PROPERTY LINES SHALL BE CONSIDERED GENERAL CONSTRUCTION LIMITS UNLESS OTHERWISE NOTED ON THE DRAWINGS. WORK WITHIN THE GENERAL CONSTRUCTION LIMITS SHALL INCLUDE STAGING, EMOLITION AND CLEAN-UP OPERATIONS AS WELL AS CONSTRUCTION SHOWN ON THE DRAWINGS.
- INOR WORK OUTSIDE OF THE GENERAL CONSTRUCTION LIMITS SHALL BE ALLOWED AS SHOWN ON THE PLAN AND PER CITY REQUIREMENTS.
- DAMAGE BEYOND THE PROPERTY LIMITS CAUSED BY CONSTRUCTION ACTIVITY SHALL BE REPAIRED IN A MANNER APPROVED BY THE ENGINEER/LANDSCAPE ARCHITECT OR IN ACCORDANCE WITH THE CITY.
- PROPOSED WORK (BUILDING AND CIVIL) SHALL NOT DISTURB EXISTING UTILITIES UNLESS OTHERWISE SHOWN ON THE DRAWINGS AND APPROVED BY THE CITY PRIOR TO CONSTRUCTION.
- SITE SECURITY MAY BE NECESSARY AND PROVIDED IN A MANNER TO PROHIBIT VANDALISM, AND THEFT, DURING AND AFTER NORMAL WORK HOURS, THROUGHOUT THE DURATION OF THE CONTRACT. SECURITY MATERIALS SHALL BE IN ACCORDANCE WITH THE CITY.
- 'EHICULAR ACCESS TO THE SITE SHALL BE MAINTAINED FOR DELIVERY AND INSPECTION ACCESS DURING NORMAL OPERATING HOURS. AT NO POINT THROUGHOUT THE DURATION OF THE CONTRACT SHALL CIRCULATION OF ADJACENT STREETS BE BLOCKED WITHOUT APPROVAL BY THE CITY PRIOR TO CONSTRUCTION ACTIVITIES.
- ALL TRAFFIC CONTROLS SHALL BE PROVIDED AND ESTABLISHED PER THE REQUIREMENTS OF THE MINNESOTA MANUAL ON UNIFORM TRAFFIC CONTROL DEVICES (MMUTCD) AND THE CITY. THIS SHALL NCLUDE, BUT NOT BE LIMITED TO, SIGNAGE, BARRICADES, FLASHERS, AND FLAGGERS AS NEEDED. ALL PUBLIC STREETS SHALL REMAIN OPEN TO TRAFFIC AT ALL TIMES. NO ROAD CLOSURES SHALL BE ERMITTED WITHOUT APPROVAL BY THE CITY.
- SHORING FOR BUILDING EXCAVATION MAY BE USED AT THE DISCRETION OF THE CONTRACTOR AND AS APPROVED BY THE OWNERS REPRESENTATIVE AND THE CITY PRIOR TO CONSTRUCTION ACTIVITIES.
- TAGING, DEMOLITION, AND CLEAN-UP AREAS SHALL BE WITHIN THE PROPERTY LIMITS AS SHOWN ON THE DRAWINGS AND MAINTAINED IN A MANNER AS REQUIRED BY THE CITY.
- ALL EXISTING SITE TRAFFIC/REGULATORY SIGNAGE TO BE INVENTORIED AND IF REMOVED FOR CONSTRUCTION SHALL BE RETURNED TO LGU.
- ALL EXISTING UTILITY LOCATIONS SHOWN ARE APPROXIMATE. CONTACT "GOPHER STATE ONE CALL" (651-454-0002 OR 800-252-1166) FOR UTILITY LOCATIONS, 48 HOURS PRIOR TO CONSTRUCTION. THE CONTRACTOR SHALL REPAIR OR REPLACE ANY UTILITIES THAT ARE DAMAGED DURING CONSTRUCTION AT NO COST TO THE OWNER.

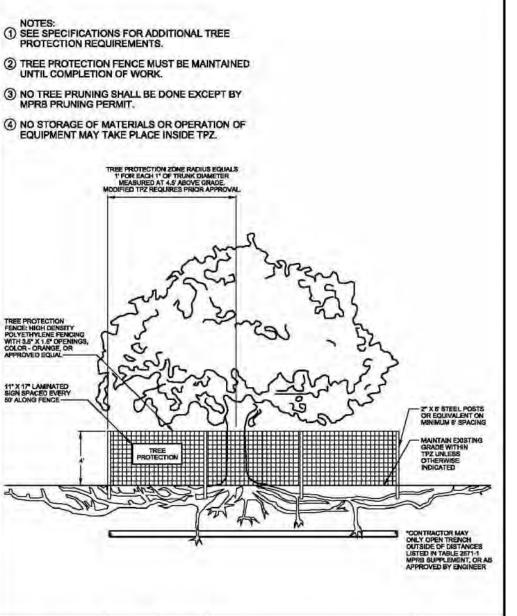

TREE PROTECTION ZONE (TPZ)

CITY OF MINNEAPOLIS REMOVAL NOTES:

- ALL EXISTING AND PROPOSED UNDERGROUND PUBLIC UTILITIES (WATER, SANITARY, AND STORM DRAIN) SHALL BE SHOWN ON THE SITE PLAN WITH CORRESPONDING PIPE SIZES AND TYPES. FOR PUBLIC WATERMAIN INFRASTRUCTURE RECORDS CALL (612)673-2865. ANY EXISTING WATER SERVICE CONNECTIONS TO THE SITE SHALL BE NOTED ON THE PLANS FOR REMOVAL, AND SHALL BE REMOVED PER THE REQUIREMENTS OF THE UTILITY CONNECTIONS DEPARTMENT BEFORE ANY NEW SERVICES LINES CAN BE INSTALLED, CALL (612)673-2451 FOR MORE INFORMATION.
- ANY EXISTING CONCRETE INFRASTRUCTURE IN THE PUBLIC RIGHT OF WAY, INCLUDING BUT NOT LIMITED TO PUBLIC SIDEWALKS, CURB AND GUTTER, AND ADA PEDESTRIAN RAMPS, THAT IS EITHER CURRENTLY DEFECTIVE OR THAT IS DAMAGED DURING THE TIME OF SITE RE-DEVELOPMENT, MUST BE REMOVED AND REPLACED AT THE TIME OF SITE RE-DEVELOPMENT.

OWNER INFORMATION

OWNER: JWT LAKE ST. LLC 2400 BLAISDELL AVE MINNEAPOLIS, MN 55404


OWNER, DEVELOPER, CONTRACTOR SIGNED STATEMENT

ALL CLEARING, GRADING, CONSTRUCTION OR DEVELOPMENT WILL BE DONE PURSUANT TO THE PLAN. SIGNED BY PARTIES BELOW:

OWNER: ____

CONTRACTOR:

REMOVALS LEGEND:

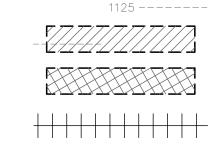

EX. 1' CONTOUR ELEVATION INTERVAL REMOVAL OF PAVEMENT AND ALL BASE MATERIAL, INCLUDING BIT., CONC., AND GRAVEL PVMTS. REMOVAL OF STRUCTURE INCLUDING ALL FOOTINGS AND FOUNDATIONS. REMOVE CURB AND GUTTER. IF IN RIGHT-OF-N
COORDINATE WITH LOCAL GOVERNING UNIT. REMOVE CURB AND GUTTER. IF IN RIGHT-OF-WAY,


TREE PROTECTION

EROSION CONTROL NOTES:

SEE SWPPP ON SHEETS SW1.0 - SW1.3

TREE REMOVAL - INCLUDING ROOTS AND STUMPS



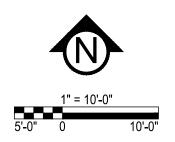

4931 W. 35th Street, Suite 200

St. Louis Park, MN 55416 civilsitegroup.com

I HEREBY CERTIFY THAT THIS PLAN, SPECIFICATION, OR REPORT WAS PREPARED BY ME OR UNDER MY DIRECT SUPERVISION AND THAT I AM A DULY LICENSED PROFESSIONAL ENGINEER UNDER THE LAWS OF THE STATE OF

Matthew R. Pavek

DATE 11/02/20 LICENSE NO. 44263 ISSUE/SUBMITTAL SUMMARY


DATE DESCRIPTION 10/08/2020 PDR SUBMITTAL 10/20/20 PDR SUBMITTAL 11/02/20 PDR SUBMITTAL

DRAWN BY:KB, KW REVIEWED BY: MP

PROJECT NUMBER: 20267 REVISION SUMMARY

DATE DESCRIPTION

REMOVALS PLAN

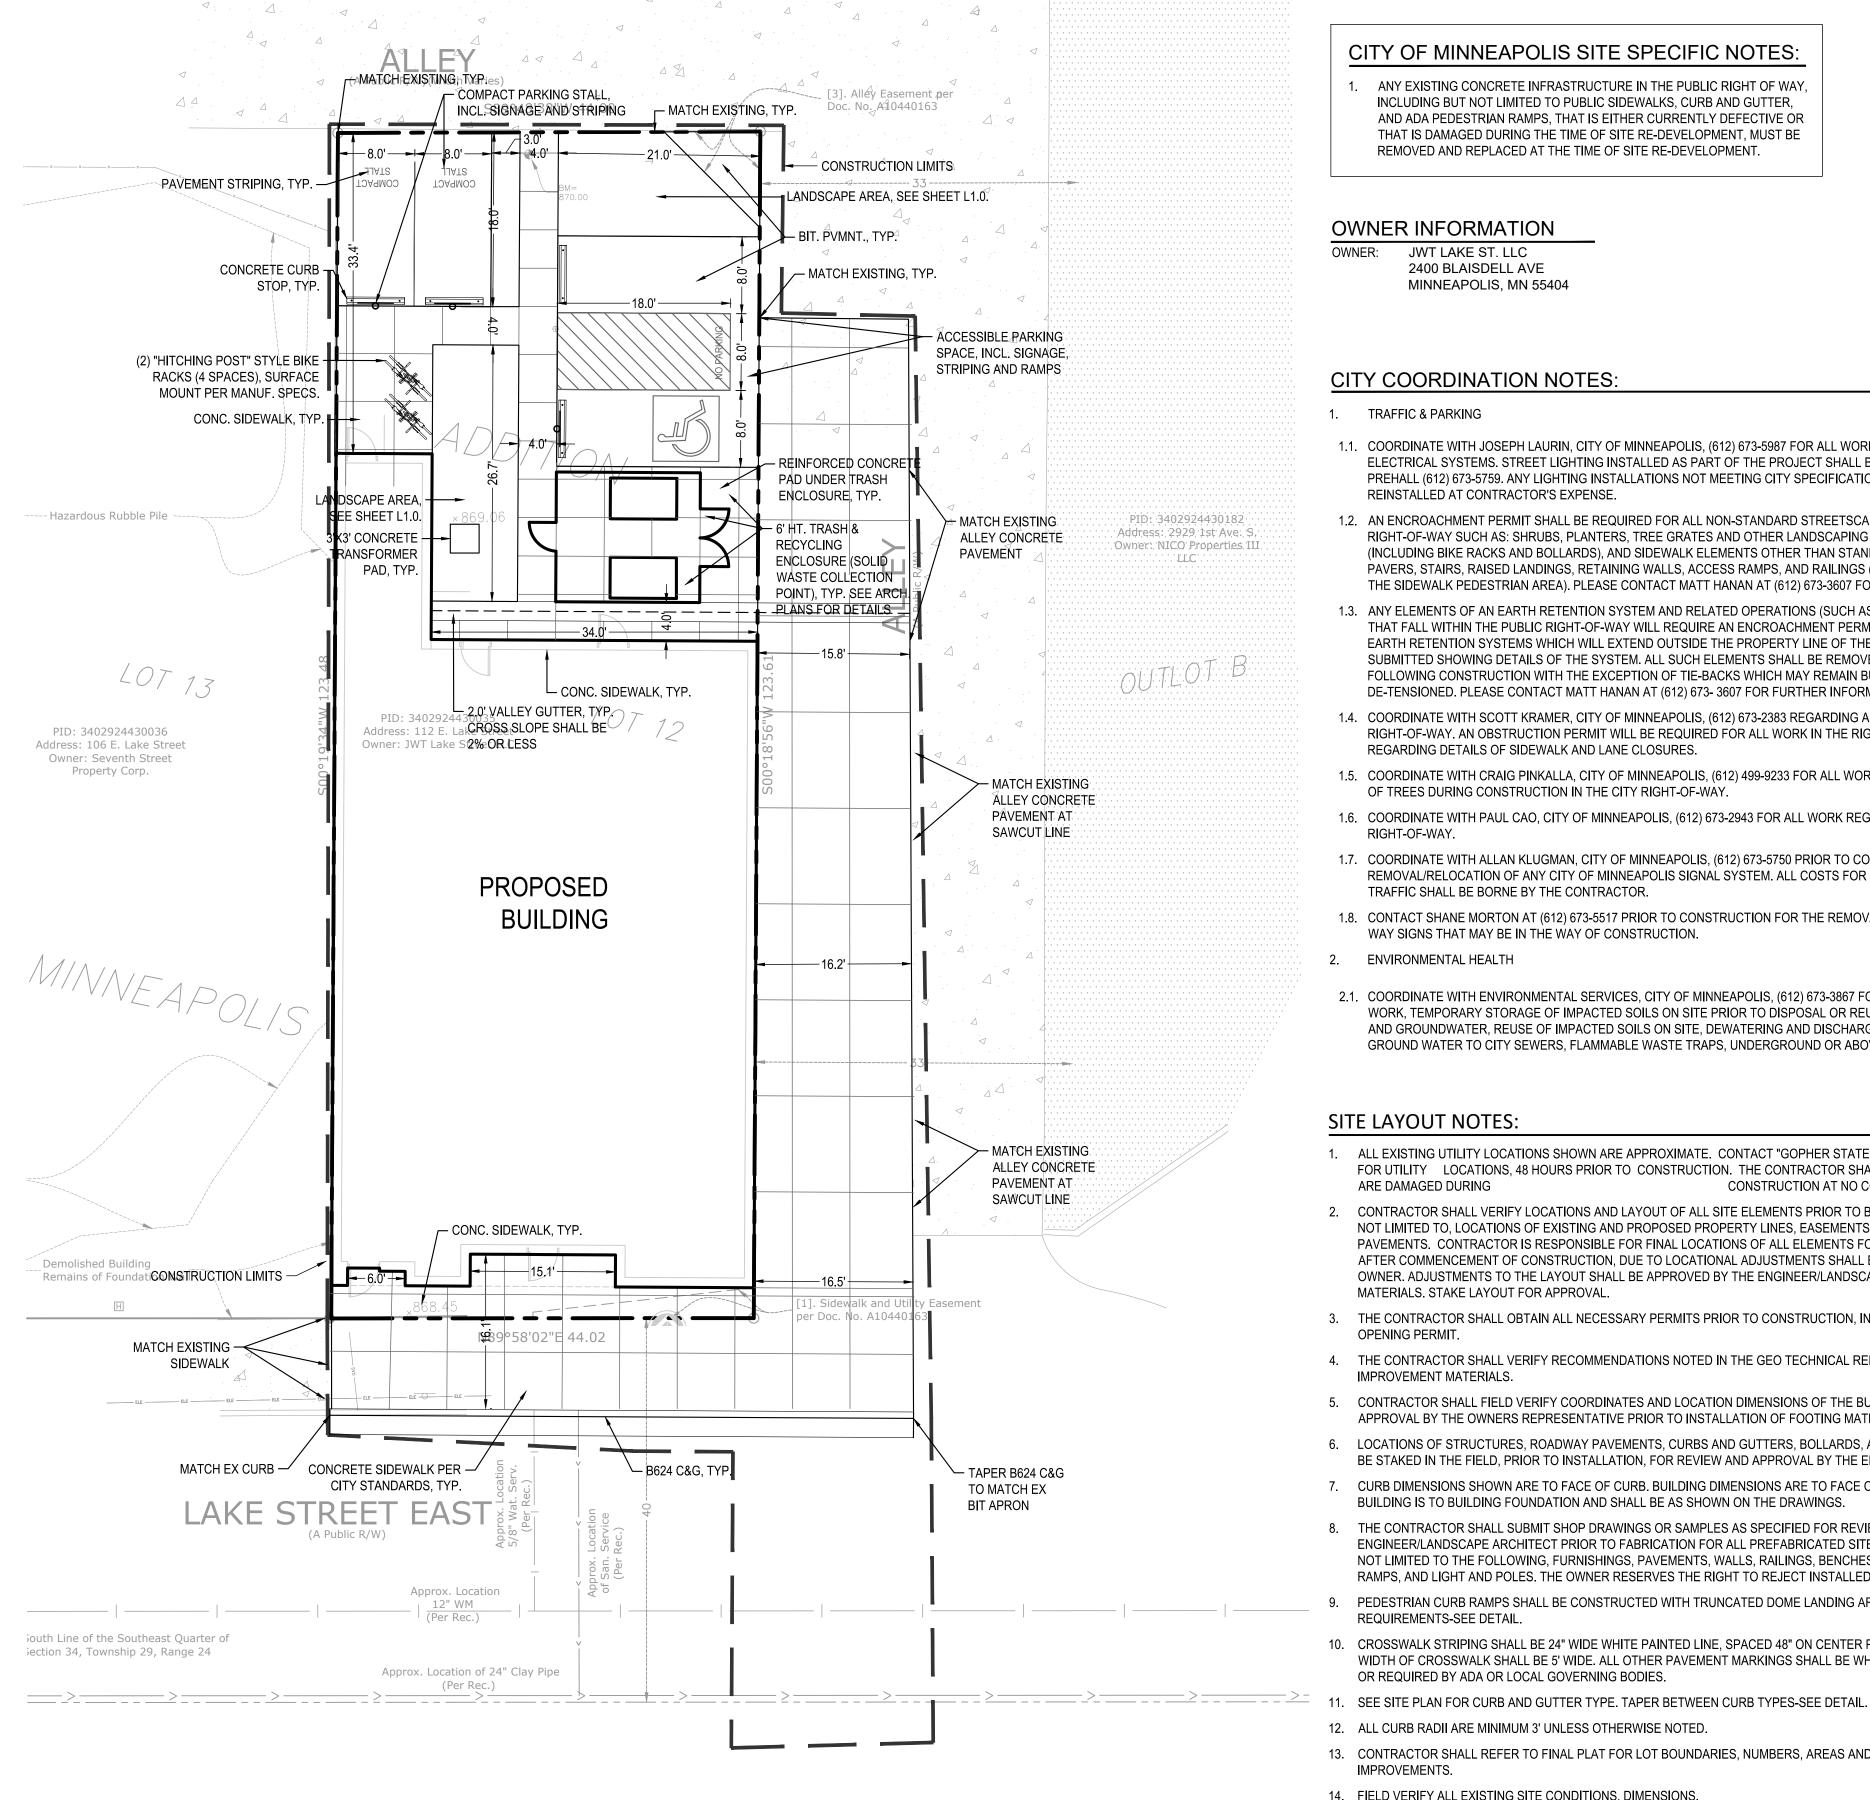

CITY OF MINNEAPOLIS SITE SPECIFIC NOTES:

ANY EXISTING CONCRETE INFRASTRUCTURE IN THE PUBLIC RIGHT OF WAY, INCLUDING BUT NOT LIMITED TO PUBLIC SIDEWALKS, CURB AND GUTTER, AND ADA PEDESTRIAN RAMPS, THAT IS EITHER CURRENTLY DEFECTIVE OR THAT IS DAMAGED DURING THE TIME OF SITE RE-DEVELOPMENT, MUST BE

REMOVED AND REPLACED AT THE TIME OF SITE RE-DEVELOPMENT.

OWNER INFORMATION

JWT LAKE ST. LLC 2400 BLAISDELL AVE MINNEAPOLIS, MN 55404

OPERATIONAL NOTES:

SNOW REMOVAL:

ALL SNOW SHALL OCCUR IN LANDSCAPE AREAS ON SITE OR WILL BE TRUCKED OFF-SITE.

TRASH REMOVAL:

TRASH REMOVAL SHALL OCCUR AT SOLID WASTE COLLECTION POINT LABELED ON SITE PLAN.

DELIVERIES:

DELIVERIES SHALL OCCUR AT BUILDING MAIN ENTRANCE.

CITY COORDINATION NOTES:

- 1.1. COORDINATE WITH JOSEPH LAURIN. CITY OF MINNEAPOLIS. (612) 673-5987 FOR ALL WORK REGARDING STREET LIGHTING AND ELECTRICAL SYSTEMS. STREET LIGHTING INSTALLED AS PART OF THE PROJECT SHALL BE INSPECTED BY THE CITY, CONTACT DAVE PREHALL (612) 673-5759. ANY LIGHTING INSTALLATIONS NOT MEETING CITY SPECIFICATIONS WILL BE REQUIRED TO BE REINSTALLED AT CONTRACTOR'S EXPENSE.
- 1.2. AN ENCROACHMENT PERMIT SHALL BE REQUIRED FOR ALL NON-STANDARD STREETSCAPE ELEMENTS IN THE PUBLIC RIGHT-OF-WAY SUCH AS: SHRUBS, PLANTERS, TREE GRATES AND OTHER LANDSCAPING ELEMENTS, SIDEWALK FURNITURE (INCLUDING BIKE RACKS AND BOLLARDS), AND SIDEWALK ELEMENTS OTHER THAN STANDARD CONCRETE WALKWAYS SUCH AS PAVERS, STAIRS, RAISED LANDINGS, RETAINING WALLS, ACCESS RAMPS, AND RAILINGS (NOTE: RAILINGS MAY NOT EXTEND INTO THE SIDEWALK PEDESTRIAN AREA). PLEASE CONTACT MATT HANAN AT (612) 673-3607 FOR FURTHER INFORMATION.
- 1.3. ANY ELEMENTS OF AN EARTH RETENTION SYSTEM AND RELATED OPERATIONS (SUCH AS CONSTRUCTION CRANE BOOM SWINGS) THAT FALL WITHIN THE PUBLIC RIGHT-OF-WAY WILL REQUIRE AN ENCROACHMENT PERMIT APPLICATION. IF THERE ARE TO BE ANY EARTH RETENTION SYSTEMS WHICH WILL EXTEND OUTSIDE THE PROPERTY LINE OF THE DEVELOPMENT THEN A PLAN MUST BE SUBMITTED SHOWING DETAILS OF THE SYSTEM. ALL SUCH ELEMENTS SHALL BE REMOVED FROM THE PUBLIC RIGHT-OF-WAY FOLLOWING CONSTRUCTION WITH THE EXCEPTION OF TIE-BACKS WHICH MAY REMAIN BUT MUST BE UNCOUPLED AND DE-TENSIONED. PLEASE CONTACT MATT HANAN AT (612) 673- 3607 FOR FURTHER INFORMATION.
- 1.4. COORDINATE WITH SCOTT KRAMER, CITY OF MINNEAPOLIS, (612) 673-2383 REGARDING ANY WORK THAT IS PERFORMED IN THE RIGHT-OF-WAY. AN OBSTRUCTION PERMIT WILL BE REQUIRED FOR ALL WORK IN THE RIGHT-OF-WAY. CONTACT SCOTT KRAMER REGARDING DETAILS OF SIDEWALK AND LANE CLOSURES.
- 1.5. COORDINATE WITH CRAIG PINKALLA, CITY OF MINNEAPOLIS, (612) 499-9233 FOR ALL WORK REGARDING REMOVAL OR PROTECTION OF TREES DURING CONSTRUCTION IN THE CITY RIGHT-OF-WAY.
- 1.6. COORDINATE WITH PAUL CAO, CITY OF MINNEAPOLIS, (612) 673-2943 FOR ALL WORK REGARDING BIKE RACKS IN THE CITY RIGHT-OF-WAY.
- 1.7. COORDINATE WITH ALLAN KLUGMAN, CITY OF MINNEAPOLIS, (612) 673-5750 PRIOR TO CONSTRUCTION FOR THE TEMPORARY REMOVAL/RELOCATION OF ANY CITY OF MINNEAPOLIS SIGNAL SYSTEM. ALL COSTS FOR RELOCATION AND/OR REPAIR OF CITY TRAFFIC SHALL BE BORNE BY THE CONTRACTOR.
- 1.8. CONTACT SHANE MORTON AT (612) 673-5517 PRIOR TO CONSTRUCTION FOR THE REMOVAL OF ANY CITY OF MINNEAPOLIS RIGHT OF WAY SIGNS THAT MAY BE IN THE WAY OF CONSTRUCTION.
- 2. ENVIRONMENTAL HEALTH
- 2.1. COORDINATE WITH ENVIRONMENTAL SERVICES, CITY OF MINNEAPOLIS, (612) 673-3867 FOR PERMITS RELATING TO AFTER HOURS WORK, TEMPORARY STORAGE OF IMPACTED SOILS ON SITE PRIOR TO DISPOSAL OR REUSE, REMEDIATION OF CONTAMINATED SOIL AND GROUNDWATER, REUSE OF IMPACTED SOILS ON SITE, DEWATERING AND DISCHARGE OF ACCUMULATED STORM WATER OR GROUND WATER TO CITY SEWERS. FLAMMABLE WASTE TRAPS. UNDERGROUND OR ABOVEGROUND TANK INSTALLATION OR

SITE LAYOUT NOTES:

- ALL EXISTING UTILITY LOCATIONS SHOWN ARE APPROXIMATE. CONTACT "GOPHER STATE ONE CALL" (651-454-0002 OR 800-252-1166) FOR UTILITY LOCATIONS, 48 HOURS PRIOR TO CONSTRUCTION. THE CONTRACTOR SHALL REPAIR OR REPLACE ANY UTILITIES THAT ARE DAMAGED DURING CONSTRUCTION AT NO COST TO THE OWNER.
- CONTRACTOR SHALL VERIFY LOCATIONS AND LAYOUT OF ALL SITE ELEMENTS PRIOR TO BEGINNING CONSTRUCTION, INCLUDING BUT NOT LIMITED TO, LOCATIONS OF EXISTING AND PROPOSED PROPERTY LINES, EASEMENTS, SETBACKS, UTILITIES, BUILDINGS AND PAVEMENTS. CONTRACTOR IS RESPONSIBLE FOR FINAL LOCATIONS OF ALL ELEMENTS FOR THE SITE. ANY REVISIONS REQUIRED AFTER COMMENCEMENT OF CONSTRUCTION, DUE TO LOCATIONAL ADJUSTMENTS SHALL BE CORRECTED AT NO ADDITIONAL COST TO OWNER. ADJUSTMENTS TO THE LAYOUT SHALL BE APPROVED BY THE ENGINEER/LANDSCAPE ARCHITECT PRIOR TO INSTALLATION OF MATERIALS. STAKE LAYOUT FOR APPROVAL.
- 3. THE CONTRACTOR SHALL OBTAIN ALL NECESSARY PERMITS PRIOR TO CONSTRUCTION, INCLUDING A RIGHT-OF-WAY AND STREET
- 4. THE CONTRACTOR SHALL VERIFY RECOMMENDATIONS NOTED IN THE GEO TECHNICAL REPORT PRIOR TO INSTALLATION OF SITE IMPROVEMENT MATERIALS.
- 5. CONTRACTOR SHALL FIELD VERIFY COORDINATES AND LOCATION DIMENSIONS OF THE BUILDING AND STAKE FOR REVIEW AND APPROVAL BY THE OWNERS REPRESENTATIVE PRIOR TO INSTALLATION OF FOOTING MATERIALS.
- 6. LOCATIONS OF STRUCTURES, ROADWAY PAVEMENTS, CURBS AND GUTTERS, BOLLARDS, AND WALKS ARE APPROXIMATE AND SHALL BE STAKED IN THE FIELD, PRIOR TO INSTALLATION, FOR REVIEW AND APPROVAL BY THE ENGINEER/LANDSCAPE ARCHITECT.
- 7. CURB DIMENSIONS SHOWN ARE TO FACE OF CURB. BUILDING DIMENSIONS ARE TO FACE OF CONCRETE FOUNDATION. LOCATION OF
- 8. THE CONTRACTOR SHALL SUBMIT SHOP DRAWINGS OR SAMPLES AS SPECIFIED FOR REVIEW AND APPROVAL BY THE ENGINEER/LANDSCAPE ARCHITECT PRIOR TO FABRICATION FOR ALL PREFABRICATED SITE IMPROVEMENT MATERIALS SUCH AS, BUT NOT LIMITED TO THE FOLLOWING, FURNISHINGS, PAVEMENTS, WALLS, RAILINGS, BENCHES, FLAGPOLES, LANDING PADS FOR CURB RAMPS, AND LIGHT AND POLES. THE OWNER RESERVES THE RIGHT TO REJECT INSTALLED MATERIALS NOT PREVIOUSLY APPROVED.
- PEDESTRIAN CURB RAMPS SHALL BE CONSTRUCTED WITH TRUNCATED DOME LANDING AREAS IN ACCORDANCE WITH A.D.A. REQUIREMENTS-SEE DETAIL.
- 10. CROSSWALK STRIPING SHALL BE 24" WIDE WHITE PAINTED LINE, SPACED 48" ON CENTER PERPENDICULAR TO THE FLOW OF TRAFFIC. WIDTH OF CROSSWALK SHALL BE 5' WIDE. ALL OTHER PAVEMENT MARKINGS SHALL BE WHITE IN COLOR UNLESS OTHERWISE NOTED OR REQUIRED BY ADA OR LOCAL GOVERNING BODIES.
- 12. ALL CURB RADII ARE MINIMUM 3' UNLESS OTHERWISE NOTED.
- 13. CONTRACTOR SHALL REFER TO FINAL PLAT FOR LOT BOUNDARIES, NUMBERS, AREAS AND DIMENSIONS PRIOR TO SITE IMPROVEMENTS.
- 14. FIELD VERIFY ALL EXISTING SITE CONDITIONS, DIMENSIONS.
- 15. PARKING IS TO BE SET PARALLEL OR PERPENDICULAR TO EXISTING BUILDING UNLESS NOTED OTHERWISE
- 16. ALL PARKING LOT PAINT STRIPPING TO BE WHITE, 4" WIDE TYP.
- 17. BITUMINOUS PAVING TO BE "LIGHT DUTY" UNLESS OTHERWISE NOTED. SEE DETAIL SHEETS FOR PAVEMENT SECTIONS.
- 18. ALL TREES THAT ARE TO REMAIN ARE TO BE PROTECTED FROM DAMAGE WITH A CONSTRUCTION FENCE AT THE DRIP LINE. SEE LANDSCAPE DOCUMENTS.
- 19. ALL EXISTING UTILITY LOCATIONS SHOWN ARE APPROXIMATE. CONTACT "GOPHER STATE ONE CALL" (651-454-0002 OR 800-252-1166) FOR UTILITY LOCATIONS, 48 HOURS PRIOR TO CONSTRUCTION. THE CONTRACTOR SHALL REPAIR OR REPLACE ANY UTILITIES THAT ARE DAMAGED DURING CONSTRUCTION AT NO COST TO THE OWNER.

REMOVAL, WELL CONSTRUCTION OR SEALING, OR ON-SITE ROCK CRUSHING.

- 2.2. NO CONSTRUCTION, DEMOLITION OR COMMERCIAL POWER MAINTENANCE EQUIPMENT SHALL BE OPERATED WITHIN THE CITY BETWEEN THE HOURS OF 6:00 PM AND 7:00 AM ON WEEKDAYS OR DURING ANY HOURS ON SATURDAYS, SUNDAYS AND STATE AND FEDERAL HOLIDAYS, EXCEPT UNDER PERMIT.
- 2.3. IF CONTAMINATED SOIL IS ENCOUNTERED, IT MUST BE REPORTED TO THE MINNESOTA DUTY OFFICER AT (651) 649-5451. PREAPPROVAL FOR REMOVAL OR REUSE MUST OCCUR FROM THE MPCA AND THE CITY OF MINNEAPOLIS.
- 2.4. IF IMPACTED SOIL IS ENCOUNTERED DURING SITE ACTIVITIES WORK WILL NEED TO STOP AND NOTIFICATION PROVIDED TO THE MN STATE DUTY OFFICER AT (615) 649-5451.
- 2.5. THE HIGHEST GROUNDWATER LEVEL EXPECTED FOR THIS SITE SHOULD BE DETERMINED AND USED IN ESTABLISHING THE LOWEST LEVEL FOR SUBGRADE STRUCTURES. IF SOIL BORINGS DEEPER THAN 15 FEET MUST BE DONE A TEMPORARY ENVIRONMENTAL WELL PERMIT MUST BE OBTAINED BY ENVIRONMENTAL SERVICES. IF DEWATERING IS REQUIRED DURING SITE CONSTRUCTION SEE BELOW FOR CITY PERMIT REQUIREMENTS. SUBGRADE STRUCTURES SHOULD BE DESIGNED TO PREVENT INFILTRATION OF GROUNDWATER WITHOUT THE NEED FOR A PERMANENT DEWATERING SYSTEM BEING INSTALLED. IF A CONTINUOUSLY OPERATING PERMANENT DEWATERING SYSTEM IS NEEDED IT MUST BE APPROVED AS PART OF THE SANITARY SEWER AND STORM DRAIN SITE PLAN APPROVAL PRIOR TO CONSTRUCTION BEGINNING.
- 2.6. NO CONSTRUCTION, DEMOLITION OR COMMERCIAL POWER MAINTENANCE EQUIPMENT SHALL BE OPERATED WITHIN THE CITY BETWEEN THE HOURS OF 6:00 P.M. AND 7:00 A.M. ON WEEKDAYS OR DURING ANY HOURS ON SATURDAYS, SUNDAYS AND STATE AND FEDERAL HOLIDAYS, EXCEPT UNDER PERMIT. CONTACT ENVIRONMENTAL SERVICES AT 612-673-3516 FOR PERMIT INFORMATION.
- 2.7. PERMITS AND APPROVAL ARE REQUIRED FROM ENVIRONMENTAL SERVICES FOR THE FOLLOWING ACTIVITIES: TEMPORARY STORAGE OF IMPACTED SOILS ON SITE PRIOR TO DISPOSAL OR REUSE; REUSE OF IMPACTED SOILS ON SITE; DEWATERING AND DISCHARGE OF ACCUMULATED STORM WATER OR GROUND WATER, UNDERGROUND OR ABOVEGROUND TANK INSTALLATION OR REMOVAL, TEMPORARY ENVIRONMENTAL WELLS, WELL CONSTRUCTION OR SEALING. CONTACT TOM FRAME AT 612-673-5807 FOR PERMIT APPLICATIONS AND
- FORESTRY DEPARTMENT
- 3.1. TO PROTECT ROOT ZONES, NO CONSTRUCTION EQUIPMENT OR MATERIALS SHALL BE PLACED, PARKED, OR STORED ON ANY UNPAVED AREA WITHIN THE DRIP LINE OF ANY CITY OWNED TREE. NO CHEMICALS OR PETROLEUM PRODUCTS SHALL BE DEPOSITED ON ANY UNPAVED AREA IN THE CITY RIGHT-OF-WAY.
- 3.2. ANY TREE ROOTS ENCOUNTERED ARE TO BE CLEANLY CUT USING HAND TOOLS.
- 3.3. NO OPEN EXCAVATION OR BORE PITS ALLOWED WITHIN 8 FEET OF CITY STREET TREES.
- 3.4. CARE SHALL BE TAKEN NOT TO DAMAGE TREE TRUNKS OR BRANCHES. CONTRACTOR MUST CONTACT FORESTRY DEPARTMENT INSPECTIONS (CRAIG PINKALLA) AT (612) 499-9233 AT LEAST 3 DAYS PRIOR TO STARTING WORK TO DISCUSS PROBLEMS OF OVERHANGING BRANCHES THAT MAY BE DAMAGED.

SITE AREA TABLE:

	EXISTIN	G	PROPO:	SED
BUILDING COVERAGE	2,265 SF	41.7%	3,319 SF	61.0%
ALL PAVEMENTS	2,660 SF	48.9%	1,653 SF	30.4%
ALL NON-PAVEMENTS	512 SF	9.4%	465 SF	8.6%
TOTAL SITE AREA	5,437 SF	100.0%	5,437 SF	100.0%

MPERVIOUS SURFACE		
XISTING CONDITION	4,925 SF	90.6%
ROPOSED CONDITION	4,972 SF	91.4%
OIFFERENCE (EX. VS PROP.)	47 SF	0.9%
MPERVIOUS TOTAL	4.972 SF	91.4%

SITE PLAN LEGEND:

BITUMINOUS PAVEMENT (IF APPLICABLE). SEE GEOTECHNICAL REPORT FOR AGGREGATE BASE & WEAR COURSE DEPTH, SEE DEATIL. CONCRETE PAVEMENT (IF APPLICABLE) AS SPECIFIED (PAD OR WALK) SEE GEOTECHNICAL REPORT FOR AGGREGATE BASE & CONCRETE DEPTHS, SEE DETAIL.

PROPERTY LINE

CONSTRUCTION LIMITS CURB AND GUTTER-SEE NOTES (T.O.) TIP OUT GUTTER WHERE APPLICABLE-SEE PLAN




TRAFFIC DIRECTIONAL ARROW PAVEMENT MARKINGS




Know what's **below**.

Call before you dig.

SIGN AND POST ASSEMBLY. SHOP DRAWINGS REQUIRED. HC = ACCESSIBLE SIGN NP = NO PARKING FIRE LANE ST = STOP CP = COMPACT CAR PARKING ONLY ACCESSIBILITY ARROW (IF APPLICABLE) DO NOT

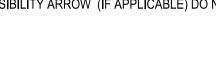

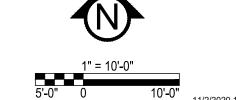

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St. Louis Park, MN 55416

OELIMINARY.

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I HEREBY CERTIFY THAT THIS PLAN, SPECIFICATION, OR REPORT WAS PREPARED BY ME OR UNDER MY DIRECT SUPERVISION AND THAT I AM A DULY LICENSED PROFESSIONAL ENGINEER UNDER THE LAWS OF THE STATE OF

Matthew R. Pavek


DATE 11/02/20 LICENSE NO. 44263 ISSUE/SUBMITTAL SUMMARY

DATE DESCRIPTION 10/08/2020 PDR SUBMITTAL 10/20/20 PDR SUBMITTAL 11/02/20 PDR SUBMITTAL

DRAWN BY:KB. KW REVIEWED BY: MP PROJECT NUMBER: 20267 REVISION SUMMARY

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SITE PLAN

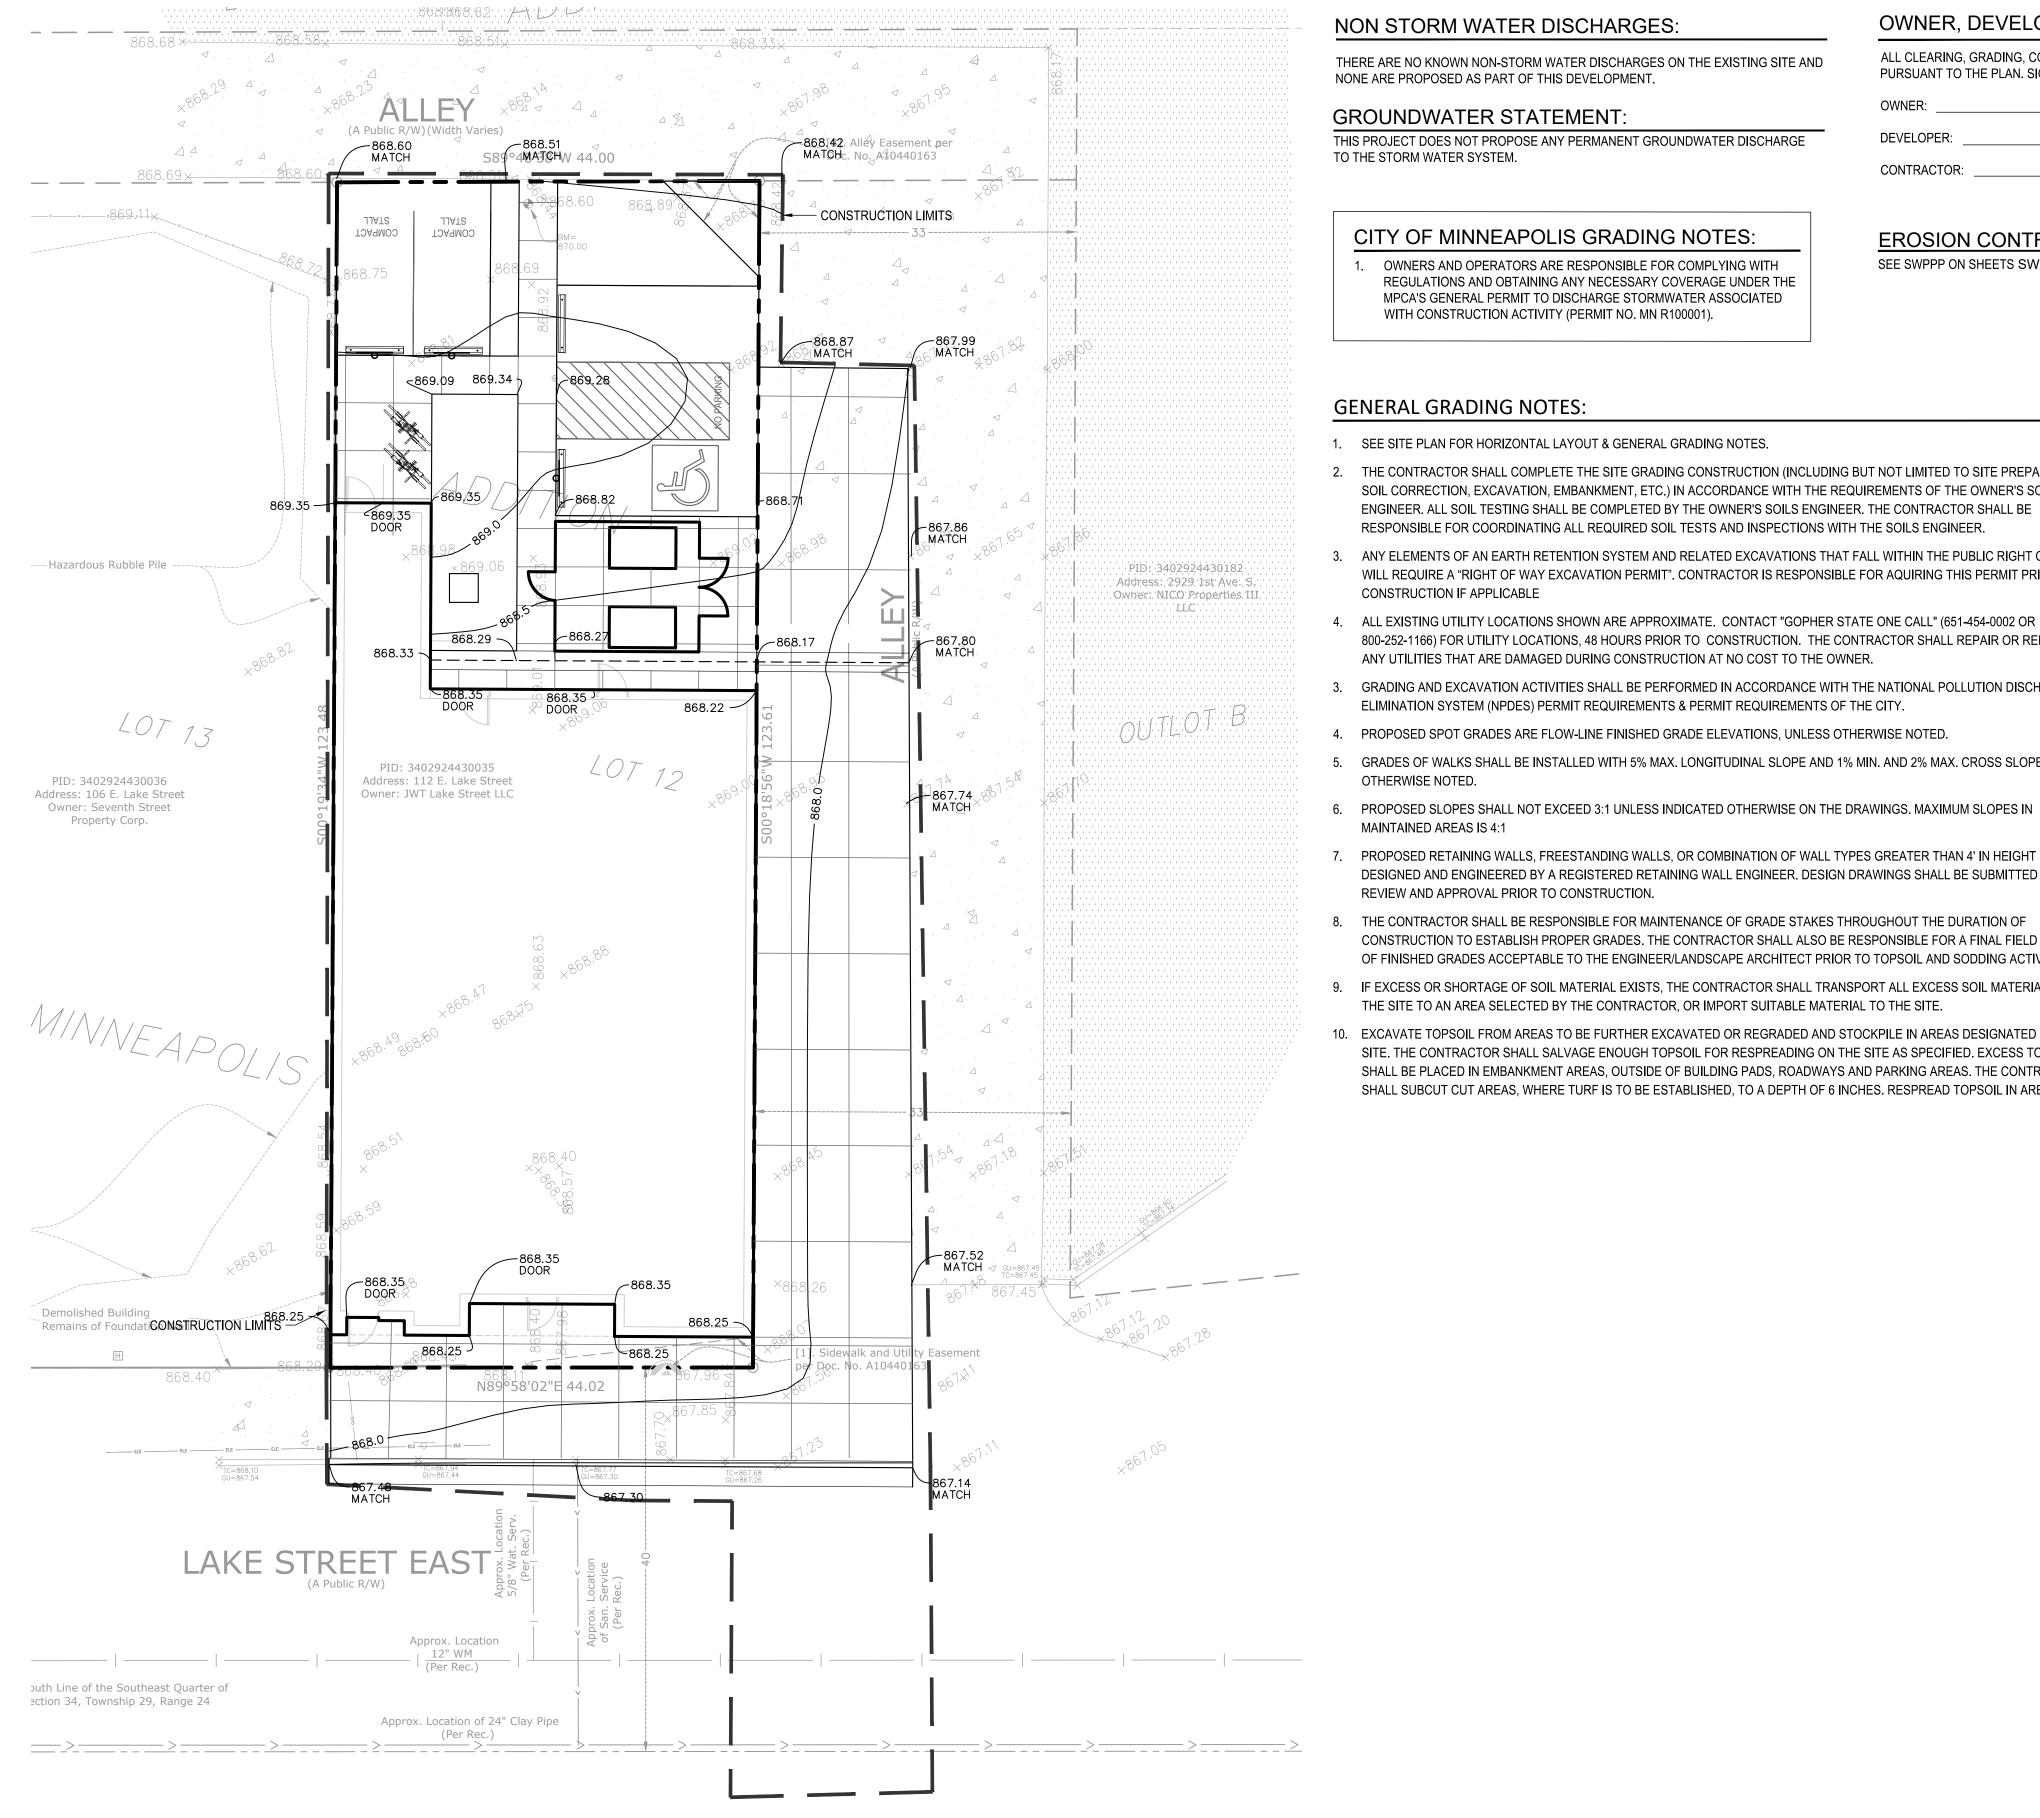

NON STORM WATER DISCHARGES:

THERE ARE NO KNOWN NON-STORM WATER DISCHARGES ON THE EXISTING SITE AND NONE ARE PROPOSED AS PART OF THIS DEVELOPMENT.

GROUNDWATER STATEMENT:

THIS PROJECT DOES NOT PROPOSE ANY PERMANENT GROUNDWATER DISCHARGE TO THE STORM WATER SYSTEM.

CITY OF MINNEAPOLIS GRADING NOTES:

OWNERS AND OPERATORS ARE RESPONSIBLE FOR COMPLYING WITH REGULATIONS AND OBTAINING ANY NECESSARY COVERAGE UNDER THE MPCA'S GENERAL PERMIT TO DISCHARGE STORMWATER ASSOCIATED WITH CONSTRUCTION ACTIVITY (PERMIT NO. MN R100001).

OWNER, DEVELOPER, CONTRACTOR SIGNED STATEMENT

ALL CLEARING, GRADING, CONSTRUCTION OR DEVELOPMENT WILL BE DONE PURSUANT TO THE PLAN. SIGNED BY PARTIES BELOW: CONTRACTOR:

EROSION CONTROL NOTES:

SEE SWPPP ON SHEETS SW1.0 - SW1.3

GENERAL GRADING NOTES:

- 1. SEE SITE PLAN FOR HORIZONTAL LAYOUT & GENERAL GRADING NOTES.
- 2. THE CONTRACTOR SHALL COMPLETE THE SITE GRADING CONSTRUCTION (INCLUDING BUT NOT LIMITED TO SITE PREPARATION. SOIL CORRECTION, EXCAVATION, EMBANKMENT, ETC.) IN ACCORDANCE WITH THE REQUIREMENTS OF THE OWNER'S SOILS ENGINEER. ALL SOIL TESTING SHALL BE COMPLETED BY THE OWNER'S SOILS ENGINEER. THE CONTRACTOR SHALL BE RESPONSIBLE FOR COORDINATING ALL REQUIRED SOIL TESTS AND INSPECTIONS WITH THE SOILS ENGINEER.
- 3. ANY ELEMENTS OF AN EARTH RETENTION SYSTEM AND RELATED EXCAVATIONS THAT FALL WITHIN THE PUBLIC RIGHT OF WAY WILL REQUIRE A "RIGHT OF WAY EXCAVATION PERMIT". CONTRACTOR IS RESPONSIBLE FOR AQUIRING THIS PERMIT PRIOR TO CONSTRUCTION IF APPLICABLE
- 800-252-1166) FOR UTILITY LOCATIONS, 48 HOURS PRIOR TO CONSTRUCTION. THE CONTRACTOR SHALL REPAIR OR REPLACE ANY UTILITIES THAT ARE DAMAGED DURING CONSTRUCTION AT NO COST TO THE OWNER.
- 3. GRADING AND EXCAVATION ACTIVITIES SHALL BE PERFORMED IN ACCORDANCE WITH THE NATIONAL POLLUTION DISCHARGE ELIMINATION SYSTEM (NPDES) PERMIT REQUIREMENTS & PERMIT REQUIREMENTS OF THE CITY.
- 4. PROPOSED SPOT GRADES ARE FLOW-LINE FINISHED GRADE ELEVATIONS, UNLESS OTHERWISE NOTED.
- 5. GRADES OF WALKS SHALL BE INSTALLED WITH 5% MAX. LONGITUDINAL SLOPE AND 1% MIN. AND 2% MAX. CROSS SLOPE, UNLESS
- 6. PROPOSED SLOPES SHALL NOT EXCEED 3:1 UNLESS INDICATED OTHERWISE ON THE DRAWINGS. MAXIMUM SLOPES IN MAINTAINED AREAS IS 4:1
- 7. PROPOSED RETAINING WALLS, FREESTANDING WALLS, OR COMBINATION OF WALL TYPES GREATER THAN 4' IN HEIGHT SHALL BE DESIGNED AND ENGINEERED BY A REGISTERED RETAINING WALL ENGINEER. DESIGN DRAWINGS SHALL BE SUBMITTED FOR REVIEW AND APPROVAL PRIOR TO CONSTRUCTION.
- 8. THE CONTRACTOR SHALL BE RESPONSIBLE FOR MAINTENANCE OF GRADE STAKES THROUGHOUT THE DURATION OF CONSTRUCTION TO ESTABLISH PROPER GRADES. THE CONTRACTOR SHALL ALSO BE RESPONSIBLE FOR A FINAL FIELD CHECK OF FINISHED GRADES ACCEPTABLE TO THE ENGINEER/LANDSCAPE ARCHITECT PRIOR TO TOPSOIL AND SODDING ACTIVITIES.
- 9. IF EXCESS OR SHORTAGE OF SOIL MATERIAL EXISTS, THE CONTRACTOR SHALL TRANSPORT ALL EXCESS SOIL MATERIAL OFF THE SITE TO AN AREA SELECTED BY THE CONTRACTOR, OR IMPORT SUITABLE MATERIAL TO THE SITE.
- 10. EXCAVATE TOPSOIL FROM AREAS TO BE FURTHER EXCAVATED OR REGRADED AND STOCKPILE IN AREAS DESIGNATED ON THE SITE. THE CONTRACTOR SHALL SALVAGE ENOUGH TOPSOIL FOR RESPREADING ON THE SITE AS SPECIFIED. EXCESS TOPSOIL SHALL BE PLACED IN EMBANKMENT AREAS, OUTSIDE OF BUILDING PADS, ROADWAYS AND PARKING AREAS. THE CONTRACTOR SHALL SUBCUT CUT AREAS, WHERE TURF IS TO BE ESTABLISHED, TO A DEPTH OF 6 INCHES. RESPREAD TOPSOIL IN AREAS

- WHERE TURF IS TO BE ESTABLISHED TO A MINIMUM DEPTH OF 6 INCHES.
- FINISHED GRADING SHALL BE COMPLETED. THE CONTRACTOR SHALL UNIFORMLY GRADE AREAS WITHIN LIMITS OF GRADING. INCLUDING ADJACENT TRANSITION AREAS. PROVIDE A SMOOTH FINISHED SURFACE WITHIN SPECIFIED TOLERANCES, WITH UNIFORM LEVELS OR SLOPES BETWEEN POINTS WHERE ELEVATIONS ARE SHOWN, OR BETWEEN SUCH POINTS AND EXISTING GRADES. AREAS THAT HAVE BEEN FINISH GRADED SHALL BE PROTECTED FROM SUBSEQUENT CONSTRUCTION OPERATIONS, TRAFFIC AND EROSION. REPAIR ALL AREAS THAT HAVE BECOME RUTTED BY TRAFFIC OR ERODED BY WATER OR HAS SETTLED BELOW THE CORRECT GRADE. ALL AREAS DISTURBED BY THE CONTRACTOR'S OPERATIONS SHALL BE RESTORED TO EQUAL OR BETTER THAN ORIGINAL CONDITION OR TO THE REQUIREMENTS OF THE NEW WORK.
- 12. PRIOR TO PLACEMENT OF THE AGGREGATE BASE, A TEST ROLL WILL BE REQUIRED ON THE STREET AND/OR PARKING AREA SUBGRADE. THE CONTRACTOR SHALL PROVIDE A LOADED TANDEM AXLE TRUCK WITH A GROSS WEIGHT OF 25 TONS. THE TEST ROLLING SHALL BE AT THE DIRECTION OF THE SOILS ENGINEER AND SHALL BE COMPLETED IN AREAS AS DIRECTED BY THE SOILS ENGINEER. THE SOILS ENGINEER SHALL DETERMINE WHICH SECTIONS OF THE STREET OR PARKING AREA ARE UNSTABLE. CORRECTION OF THE SUBGRADE SOILS SHALL BE COMPLETED IN ACCORDANCE WITH THE REQUIREMENTS OF THE SOILS ENGINEER. NO TEST ROLL SHALL OCCUR WITHIN 10' OF ANY UNDERGROUND STORM RETENTION/DETENTION SYSTEMS.
- 13. TOLERANCES
- 13.1. THE BUILDING SUBGRADE FINISHED SURFACE ELEVATION SHALL NOT VARY BY MORE THAN 0.30 FOOT ABOVE, OR 0.30 FOOT BELOW, THE PRESCRIBED ELEVATION AT ANY POINT WHERE MEASUREMENT IS MADE.
 - 13.2. THE STREET OR PARKING AREA SUBGRADE FINISHED SURFACE ELEVATION SHALL NOT VARY BY MORE THAN 0.05 FOOT ABOVE, OR 0.10 FOOT BELOW, THE PRESCRIBED ELEVATION OF ANY POINT WHERE MEASUREMENT IS MADE.
 - 13.3. AREAS WHICH ARE TO RECEIVE TOPSOIL SHALL BE GRADED TO WITHIN 0.30 FOOT ABOVE OR BELOW THE REQUIRED ELEVATION, UNLESS DIRECTED OTHERWISE BY THE ENGINEER.
 - 13.4. TOPSOIL SHALL BE GRADED TO PLUS OR MINUS 1/2 INCH OF THE SPECIFIED THICKNESS.
- 14. MAINTENANCE
- 14.1. THE CONTRACTOR SHALL PROTECT NEWLY GRADED AREAS FROM TRAFFIC AND EROSION, AND KEEP AREA FREE OF TRASH AND DEBRIS.
- 14.2. CONTRACTOR SHALL REPAIR AND REESTABLISH GRADES IN SETTLED, ERODED AND RUTTED AREAS TO SPECIFIED TOLERANCES. DURING THE CONSTRUCTION, IF REQUIRED, AND DURING THE WARRANTY PERIOD, ERODED AREAS WHERE TURF IS TO BE ESTABLISHED SHALL BE RESEEDED AND MULCHED.
- 14.3. WHERE COMPLETED COMPACTED AREAS ARE DISTURBED BY SUBSEQUENT CONSTRUCTION OPERATIONS OR ADVERSE WEATHER, CONTRACTOR SHALL SCARIFY, SURFACE, RESHAPE, AND COMPACT TO REQUIRED DENSITY PRIOR TO FURTHER CONSTRUCTION.

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UNDER THE LAWS OF THE STATE OF

Matthew R. Pavek DATE 11/02/20 LICENSE NO. 44263

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DRAWN BY:KB, KW REVIEWED BY: MP PROJECT NUMBER: 20267

CURB AND GUTTER (T.O = TIP OUT)

EX. 1' CONTOUR ELEVATION INTERVAL

SPOT GRADE ELEVATION (GUTTER/FLOW LINE

SPOT GRADE ELEVATION BOTTOM OF STAIRS/TOP OF STAIRS

1.0' CONTOUR ELEVATION INTERVAL

SPOT GRADE ELEVATION GUTTER

SPOT GRADE ELEVATION TOP OF CURB

SPOT GRADE ELEVATION MATCH EXISTING

UNLESS OTHERWISE NOTED)



GRADING PLAN LEGEND:

41.26

891.00 G


891.00 TC

891.00 BS/TS

891.00 ME

EMERGENCY OVERFLOW



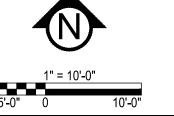


GRADE BREAK - HIGH POINTS

11/2/2020 1:03 PM

REVISION SUMMARY DATE DESCRIPTION

GRADING PLAN

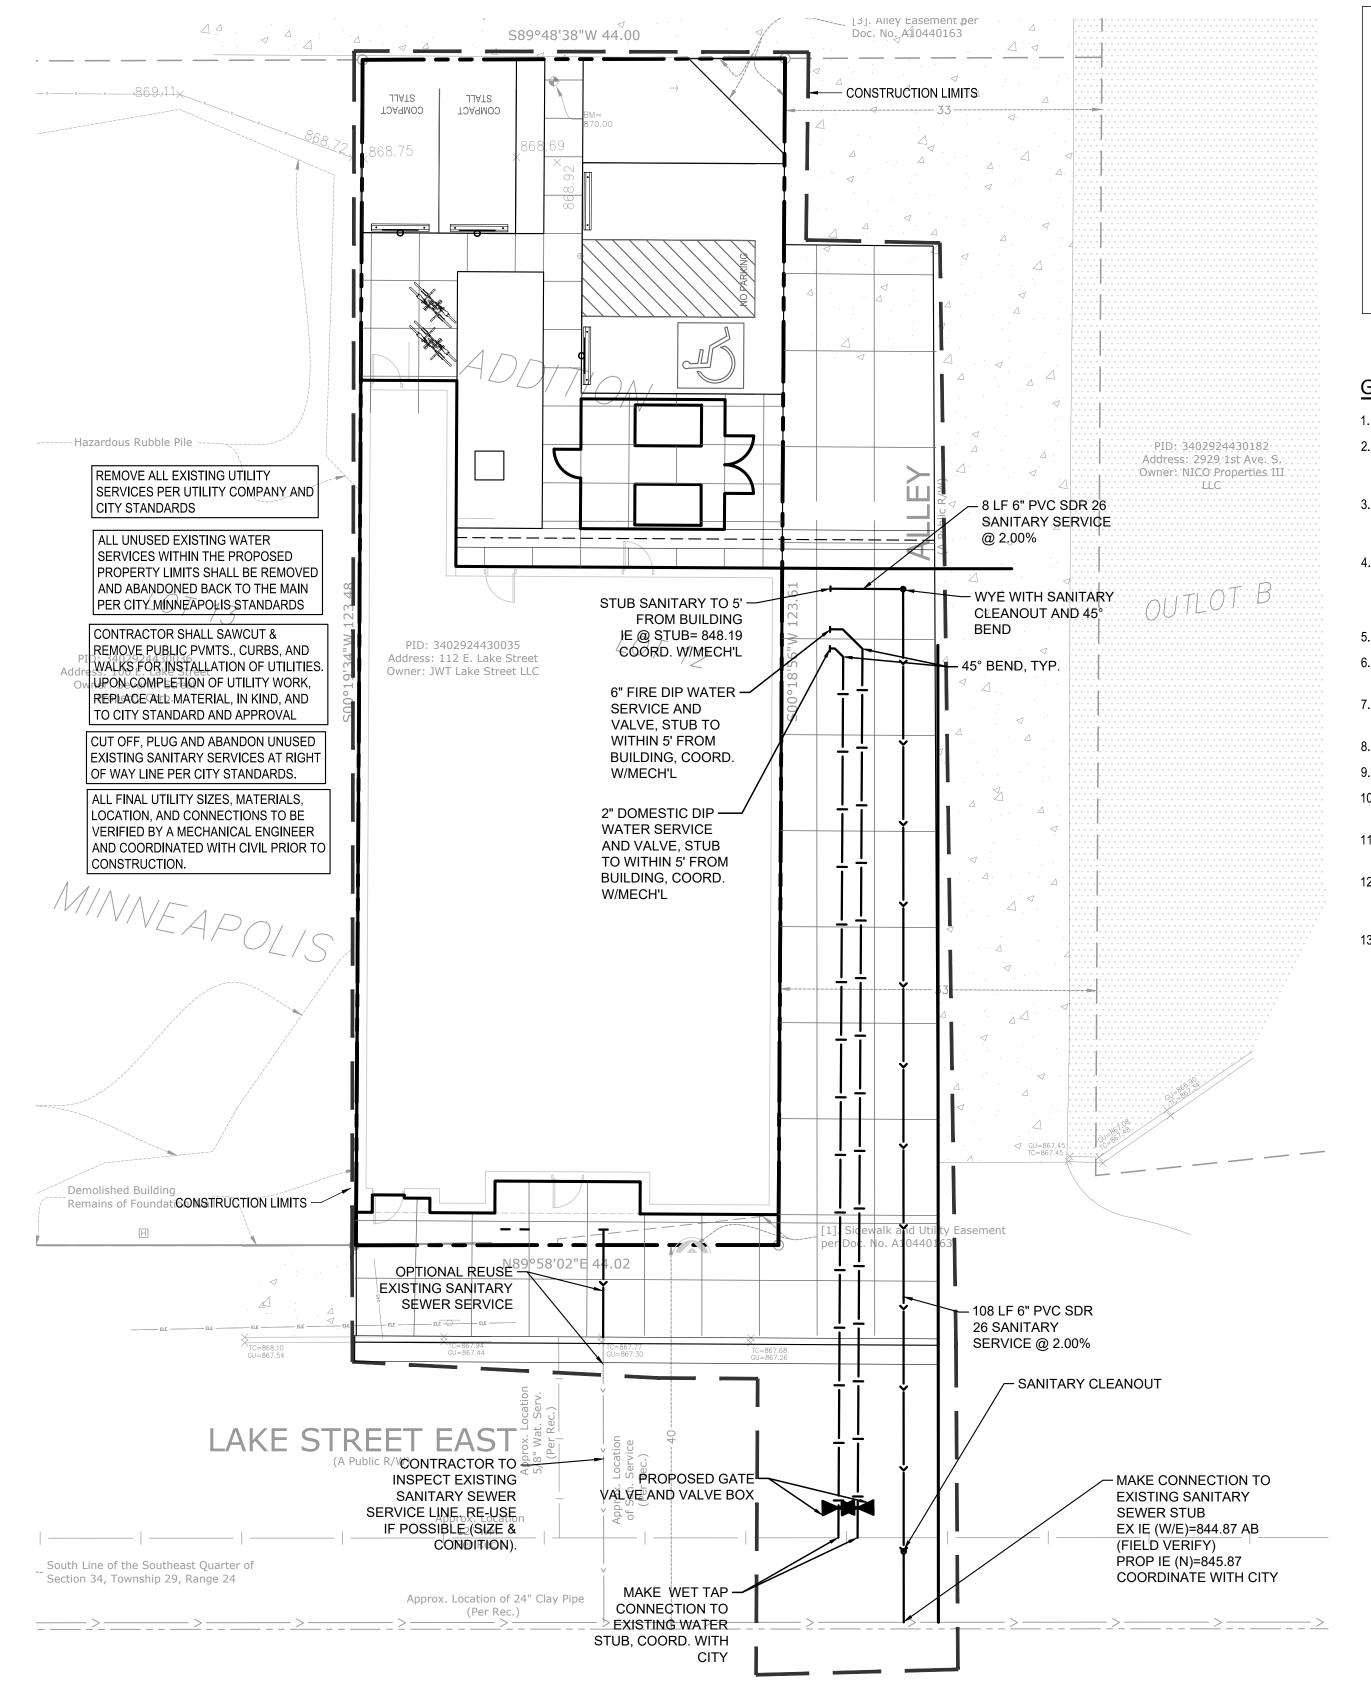

CITY OF MINNEAPOLIS UTILITY NOTES:

- 1. FOR COMMENTS OR QUESTIONS ON PUBLIC WORKS SURFACE WATER & SEWER DIVISION RELATED REQUIREMENTS PLEASE CONTACT JEREMY STREHLO, (PROFESSIONAL ENGINEER) AT (612) 673-3973, OR JEREMY.STREHLO@MINNEAPOLISMN.GOV
- 2. THE CITY OF MINNEAPOLIS WATER TREATMENT & DISTRIBUTION SERVICES DIVISION (WTDS) REQUIRES THAT POTABLE WATER SUPPLY SERVICE LINES SHALL BE SIZED BASED UPON THE TOTAL DEMAND AND SHALL BE DETERMINED IN ACCORDANCE WITH RECOGNIZED ENGINEERING METHODS AND PROCEDURES. THE APPLICANT (AND ENGINEER) SHALL BE RESPONSIBLE FOR DESIGNING POTABLE WATER SYSTEMS THAT ARE NOT OVERSIZED FOR THEIR INTENDED USE SO THAT TURNOVER IS SUFFICIENT TO MAINTAIN WATER QUALITY. PLEASE CONTACT ROCK ROGERS AT (612) 673-2286, TO CONFIRM DOMESTIC AND FIRE SERVICE DESIGN, CONNECTIONS, AND SIZES. THE APPLICANT SHALL PROVIDE A CONFIRMATION OF DOMESTIC AND FIRE SERVICE DESIGN METHODS BEFORE SITE PLAN APPROVAL CAN BE GRANTED. (NOTE: REFERS TO THE REQUIREMENT THAT LINES BE SIZED AND INCLUDE MECHANICAL ENGINEER CALCULATIONS).
- THE CONTRACTOR, PROPERTY OWNER OR RESPONSIBLE PARTY SHALL CONTACT MINNEAPOLIS SURFACE WATERS AND SEWERS 48 HOURS PRIOR TO ANY EXCAVATION OR CONSTRUCTION RELATED TO OR IN THE LOCATION OF THE PROPOSED STORMWATER MANAGEMENT BMP (CONTACT PAUL CHELLSEN 612-673-2406).
- I. UPON THE PROJECTS COMPLETION, THE GENERAL CONTRACTOR, PROPERTY OWNER, OR RESPONSIBLE PARTY SHALL PROVIDE TO THE DEPARTMENT OF PUBLIC WORKS A FINAL STORMWATER MANAGEMENT REPORT INCLUDING RECORD DRAWINGS. THIS REPORT WILL SERVE AS A MEANS OF VERIFICATION THAT THE INTENT OF THE APPROVED STORMWATER MANAGEMENT DESIGN HAS BEEN MET. THIS FINAL REPORT SHALL SUBSTANTIATE THAT ALL ASPECTS OF THE ORIGINAL DESIGN HAVE BEEN ADEQUATELY PROVIDED FOR BY THE CONSTRUCTION OF THE PROJECT.

GENERAL UTILITY NOTES:

- 1. SEE SITE PLAN FOR HORIZONTAL DIMENSIONS AND LAYOUT.
- 2. CONTRACTOR SHALL FIELD VERIFY LOCATION AND ELEVATION OF EXISTING UTILITIES AND TOPOGRAPHIC FEATURES PRIOR TO CONSTRUCTION. THE CONTRACTOR SHALL IMMEDIATELY NOTIFY THE ENGINEER OF DISCREPANCIES OR VARIATIONS FROM THE PLANS.
- ALL EXISTING UTILITY LOCATIONS SHOWN ARE APPROXIMATE. CONTACT "GOPHER STATE ONE CALL" (651-454-0002 OR 800-252-1166) FOR UTILITY LOCATIONS. 48 HOURS PRIOR TO CONSTRUCTION. THE CONTRACTOR SHALL REPAIR OR REPLACE ANY UTILITIES THAT ARE DAMAGED DURING CONSTRUCTION AT NO COST TO THE OWNER.
- 4. UTILITY INSTALLATION SHALL CONFORM TO THE CURRENT EDITION OF "STANDARD SPECIFICATIONS FOR WATER MAIN AND SERVICE LINE INSTALLATION" AND "SANITARY SEWER AND STORM SEWER INSTALLATION" AS PREPARED BY THE CITY ENGINEERS ASSOCIATION OF MINNESOTA (CEAM), AND SHALL CONFORM WITH THE REQUIREMENTS OF THE CITY AND THE PROJECT SPECIFICATIONS.
- 5. CASTINGS SHALL BE SALVAGED FROM STRUCTURE REMOVALS AND RE-USED OR PLACED AT THE DIRECTION OF THE OWNER.
- 6. ALL WATER PIPE SHALL BE CLASS 52 DUCTILE IRON PIPE (DIP) AWWA C151, ASME B16.4, AWWA C110, AWWA C153 UNLESS OTHERWISE NOTED.
- 7. ALL SANITARY SEWER SHALL BE SDR 26 POLYVINYL CHLORIDE (PVC) ASTM D3034 & F679, OR SCH 40 ASTM D1785, 2665, ASTM F794, 1866) UNLESS OTHERWISE NOTED.
- 8. ALL STORM SEWER PIPE SHALL BE HDPE ASTM F714 & F2306 WITH ASTM D3212 SPEC FITTINGS UNLESS OTHERWISE NOTED.
- 9. PIPE LENGTHS SHOWN ARE FROM CENTER TO CENTER OF STRUCTURE OR TO END OF FLARED END SECTION.
- 10. UTILITIES ON THE PLAN ARE SHOWN TO WITHIN 5' OF THE BUILDING FOOTPRINT. THE CONTRACTOR IS ULTIMATELY
- RESPONSIBLE FOR THE FINAL CONNECTION TO BUILDING LINES. COORDINATE WITH ARCHITECTURAL AND MECHANICAL PLANS.
- 11. CATCH BASINS AND MANHOLES IN PAVED AREAS SHALL BE SUMPED 0.04 FEET. ALL CATCH BASINS IN GUTTERS SHALL BE SUMPED 0.15 FEET PER DETAILS. RIM ELEVATIONS SHOWN ON THIS PLAN DO NOT REFLECT SUMPED ELEVATIONS.
- 12. A MINIMUM OF 8 FEET OF COVER IS REQUIRED OVER ALL WATERMAIN, UNLESS OTHERWISE NOTED. EXTRA DEPTH MAY BE REQUIRED TO MAINTAIN A MINIMUM OF 18" VERTICAL SEPARATION TO SANITARY OR STORM SEWER LINES. EXTRA DEPTH WATERMAIN IS INCIDENTAL.
- 13. A MINIMUM OF 18 INCHES OF VERTICAL SEPARATION AND 10 FEET OF HORIZONTAL SEPARATION IS REQUIRED FOR ALL

- UTILITIES, UNLESS OTHERWISE NOTED.
- 14. ALL CONNECTIONS TO EXISTING UTILITIES SHALL BE IN ACCORDANCE WITH CITY STANDARDS AND COORDINATED WITH THE CITY PRIOR TO CONSTRUCTION.
- 15. CONNECTIONS TO EXISTING STRUCTURES SHALL BE CORE-DRILLED.
- 16. COORDINATE LOCATIONS AND SIZES OF SERVICE CONNECTIONS WITH THE MECHANICAL DRAWINGS.
- 17. COORDINATE INSTALLATION AND SCHEDULING OF THE INSTALLATION OF UTILITIES WITH ADJACENT CONTRACTORS AND CITY
- 18. ALL STREET REPAIRS AND PATCHING SHALL BE PERFORMED PER THE REQUIREMENTS OF THE CITY. ALL PAVEMENT CONNECTIONS SHALL BE SAWCUT. ALL TRAFFIC CONTROLS SHALL BE PROVIDED BY THE CONTRACTOR AND SHALL BE ESTABLISHED PER THE REQUIREMENTS OF THE MINNESOTA MANUAL ON UNIFORM TRAFFIC CONTROL DEVICES (MMUTCD) AND THE CITY. THIS SHALL INCLUDE BUT NOT BE LIMITED TO SIGNAGE, BARRICADES, FLASHERS, AND FLAGGERS AS NEEDED. ALL PUBLIC STREETS SHALL BE OPEN TO TRAFFIC AT ALL TIMES. NO ROAD CLOSURES SHALL BE PERMITTED WITHOUT APPROVAL
- 19. ALL STRUCTURES, PUBLIC AND PRIVATE, SHALL BE ADJUSTED TO PROPOSED GRADES WHERE REQUIRED. THE REQUIREMENTS OF ALL OWNERS MUST BE COMPLIED WITH. STRUCTURES BEING RESET TO PAVED AREAS MUST MEET OWNERS REQUIREMENTS FOR TRAFFIC LOADING.
- 20. CONTRACTOR SHALL COORDINATE ALL WORK WITH PRIVATE UTILITY COMPANIES.
- 21. CONTRACTOR SHALL COORDINATE CONNECTION OF IRRIGATION SERVICE TO UTILITIES. COORDINATE THE INSTALLATION OF IRRIGATION SLEEVES NECESSARY AS TO NOT IMPACT INSTALLATION OF UTILITIES.
- 22. CONTRACTOR SHALL MAINTAIN AS-BUILT PLANS THROUGHOUT CONSTRUCTION AND SUBMIT THESE PLANS TO ENGINEER UPON COMPLETION OF WORK.
- 23. ALL JOINTS AND CONNECTIONS IN STORM SEWER SYSTEM SHALL BE GASTIGHT OR WATERTIGHT. APPROVED RESILIENT RUBBER JOINTS MUST BE USED TO MAKE WATERTIGHT CONNECTIONS TO MANHOLES, CATCHBASINS, OR OTHER STRUCTURES.
- 24. ALL PORTIONS OF THE STORM SEWER SYSTEM LOCATED WITHIN 10 FEET OF THE BUILDING OR WATER SERVICE LINE MUST BE TESTED IN ACCORDANCE WITH MN RULES, CHAPTER 4714, SECTION 1109.0.

OKLIMITARY.

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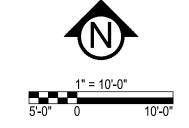
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UTILITY PLAN


UTILITY LEGEND:


CATCH BASIN MANHOLE GATE VALVE AND VALVE BOX PROPOSED FIRE HYDRANT WATER MAIN SANITARY SEWER _____ STORM SEWER





FES AND RIP RAP

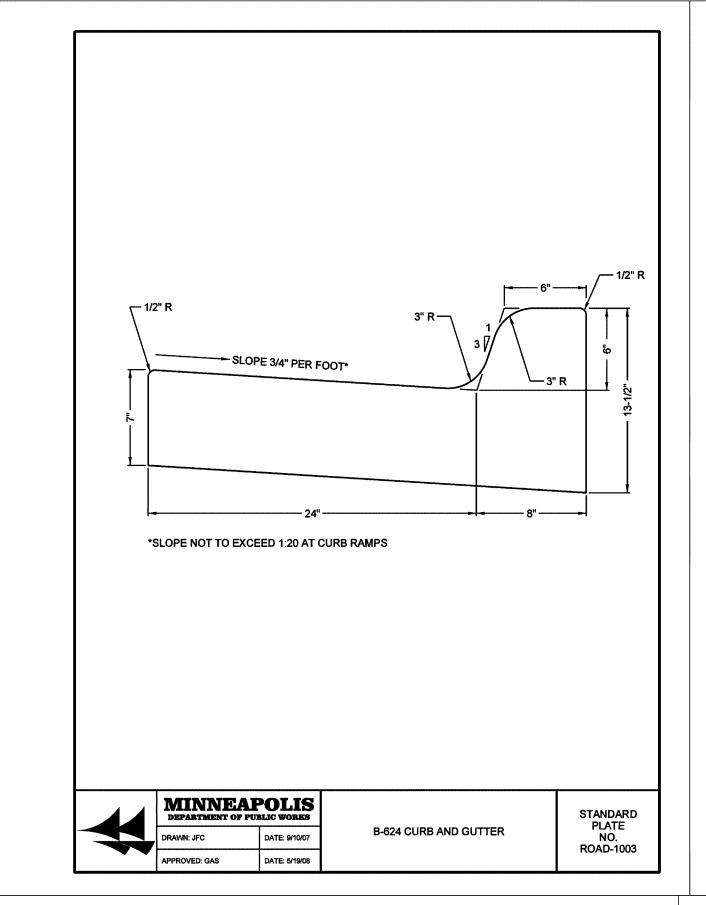

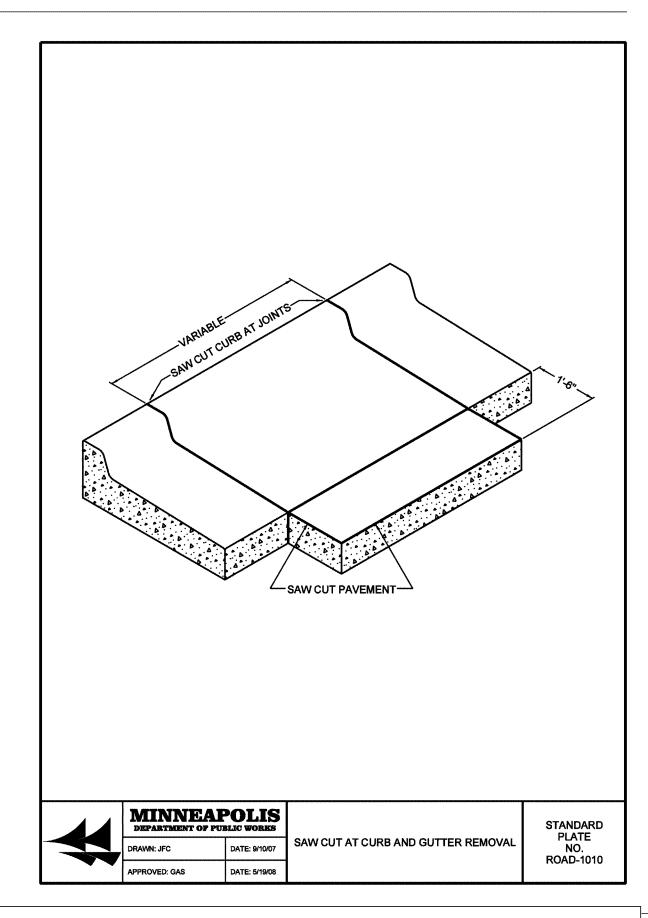

- SEWER PIPE

STAINLESS STEEL STRAP


NUTS OR WORM DRIVE SCREW


MNDOT SPEC. REF. 2503, 2506 MNDOT 4007C NOT TO SCALE


STANDARD

SEWR-3001

WITH DRAW BOLTS AND

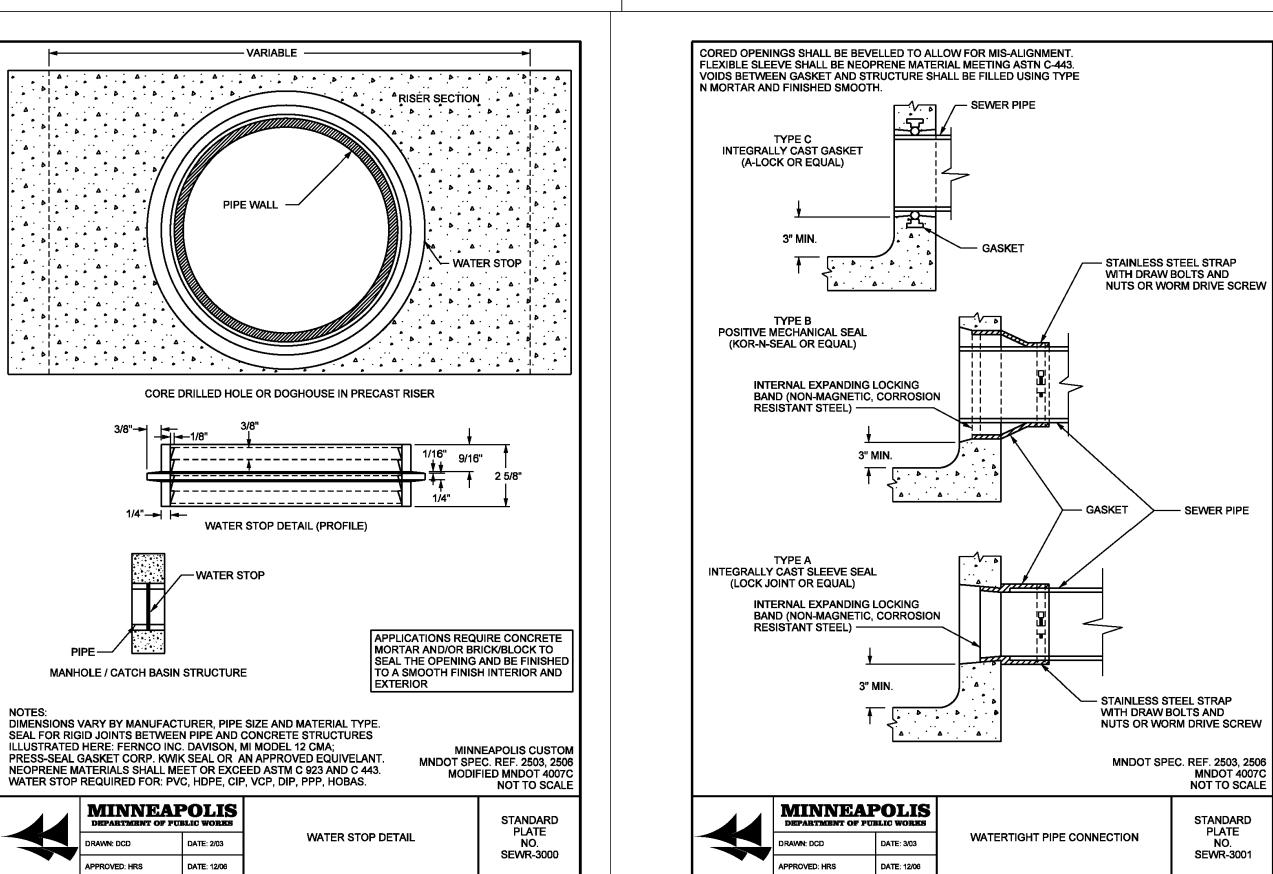

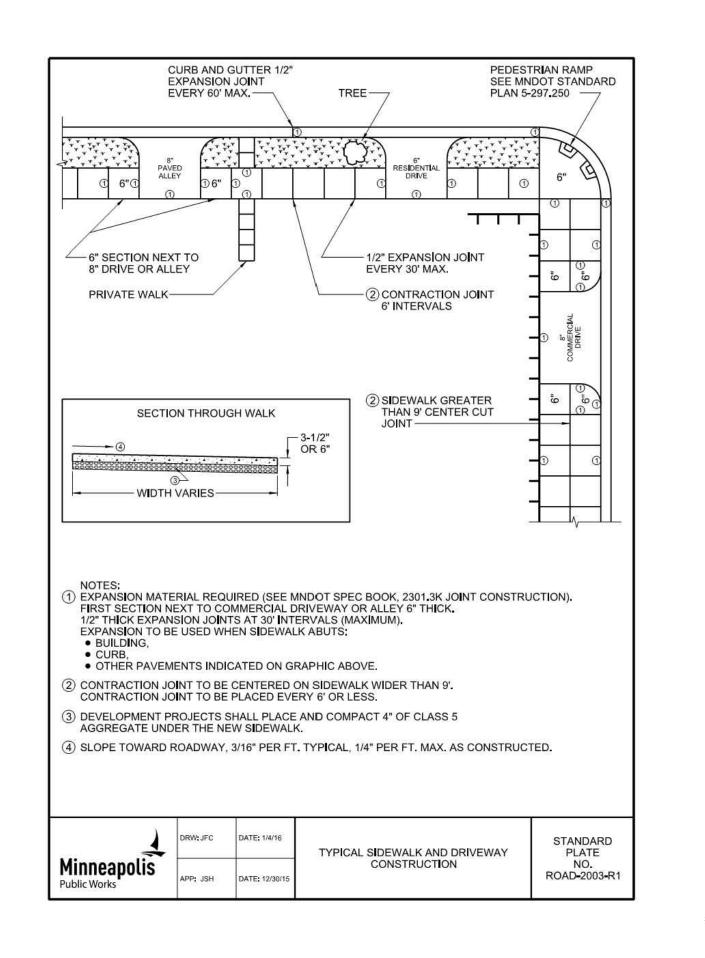

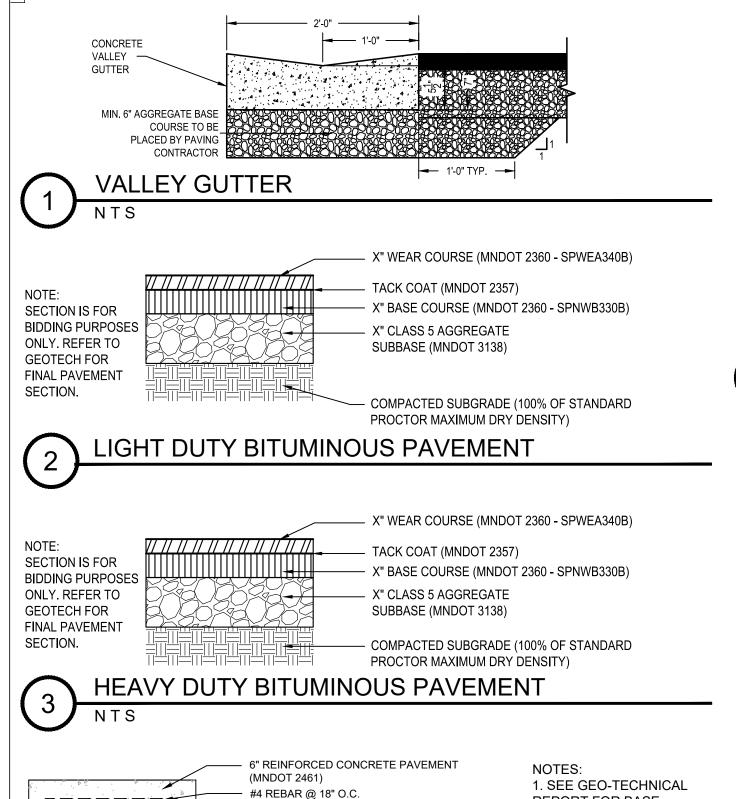


ALTERNATELY PLACED


(MNDOT 3138)

ENSURE MID-SLAD REBAR PLACEMENT

6" CLASS 5 AGGREGATE SUBBASE

- COMPACTED SUBGRADE (100% STD. PROCTOR MAX. DRY DENSITY)

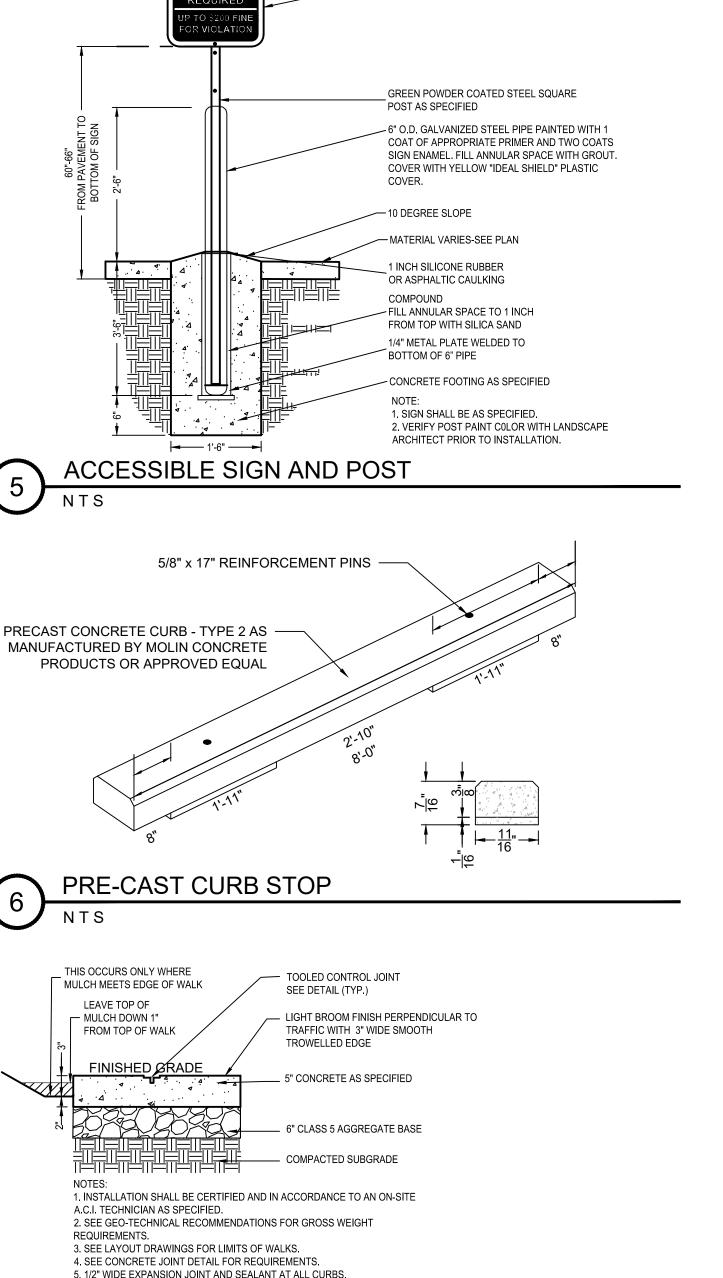

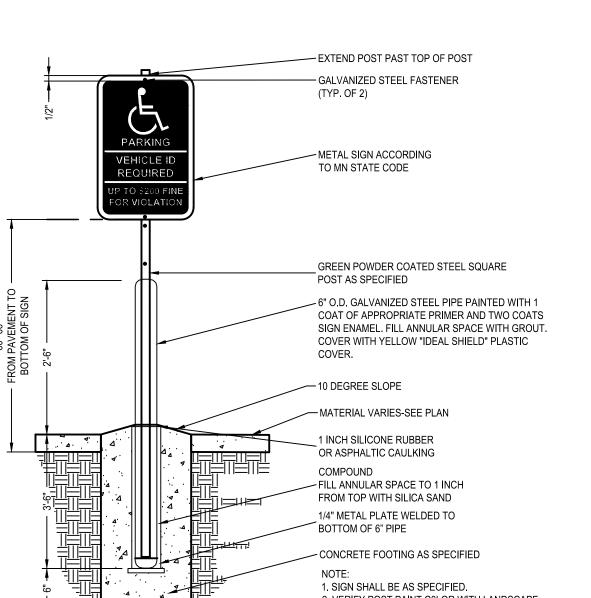

4. SEE CONCRETE JOINT DETAIL FOR REQUIREMENTS.
5. 1/2" WIDE EXPANSION JOINT AND SEALANT AT ALL CURBS.

CONCRETE WALK/PAD

(PRIVATE PROPERTY)

REPORT FOR BASE

RECOMMENDATIONS.

CERTIFIED, ON-SITE M.A.P.A. TECHNICIAN AS

SPECIFIED.

2. INSTALLATION SHALL

BE IN ACCORDANCE TO A

CIVIL DETAILS

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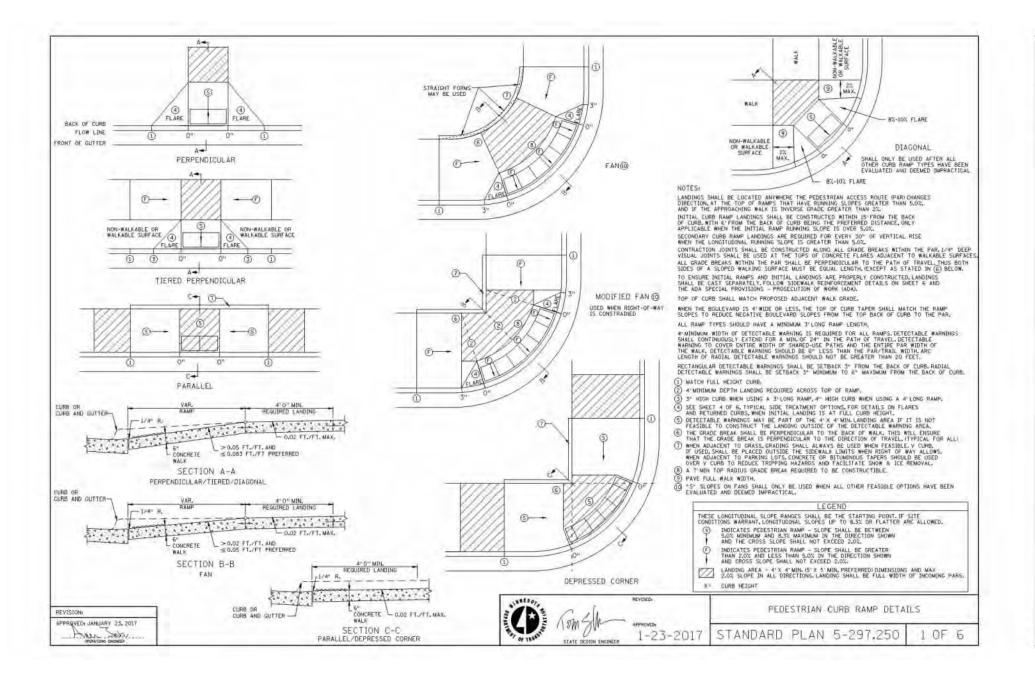
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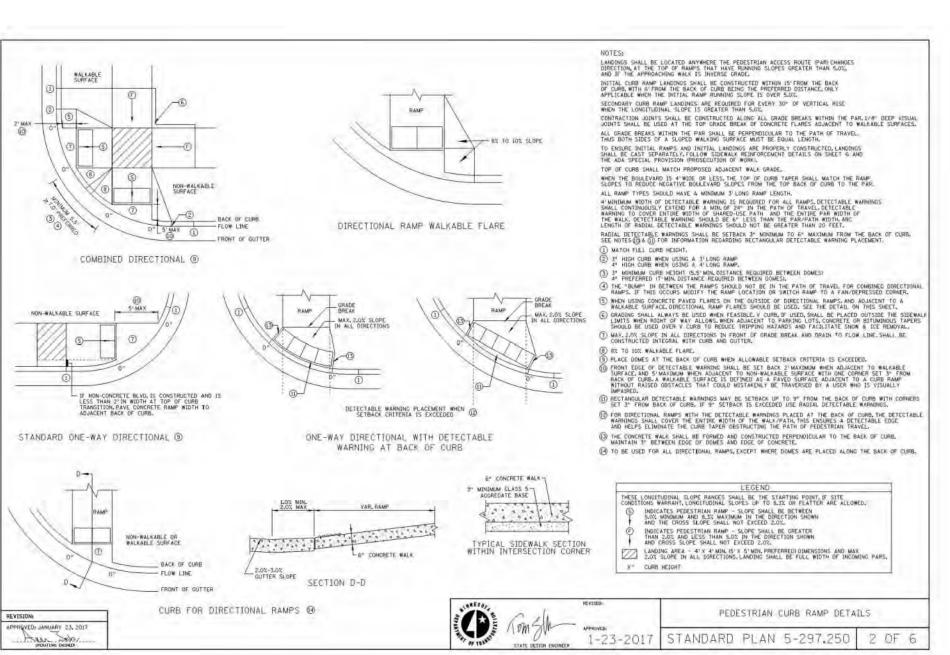
10/20/20 PDR SUBMITTAL


11/02/20 PDR SUBMITTAL


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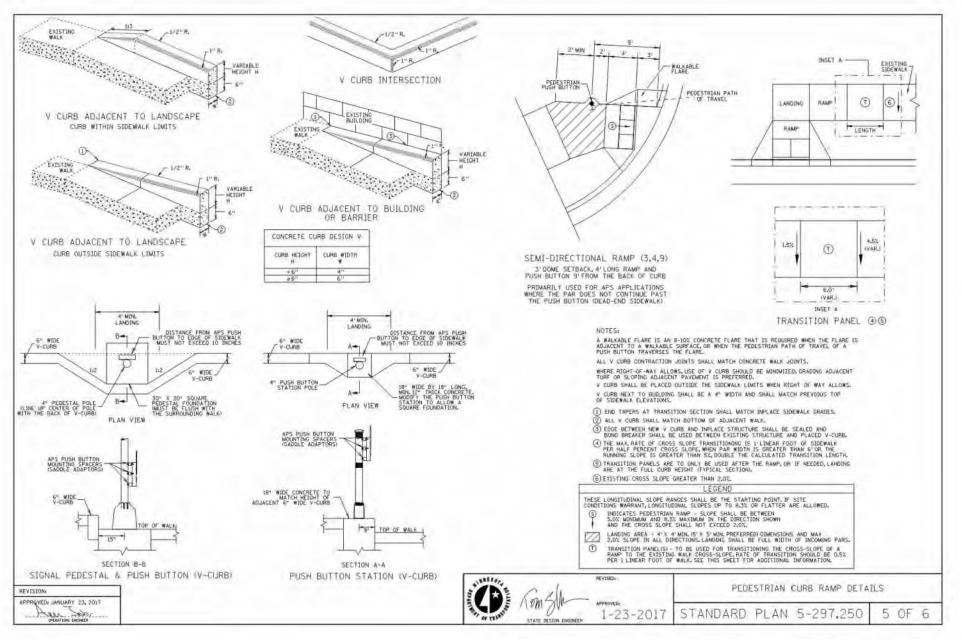
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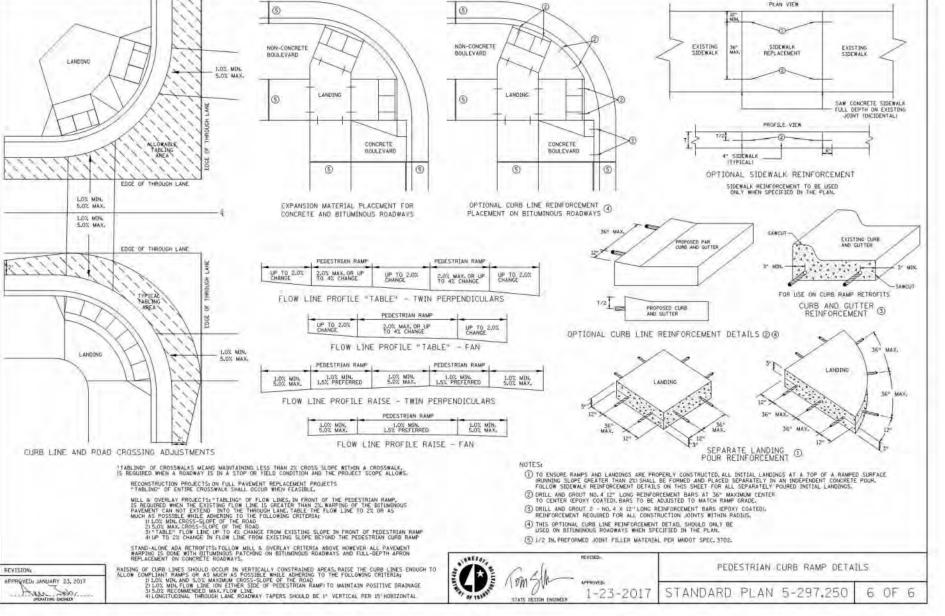








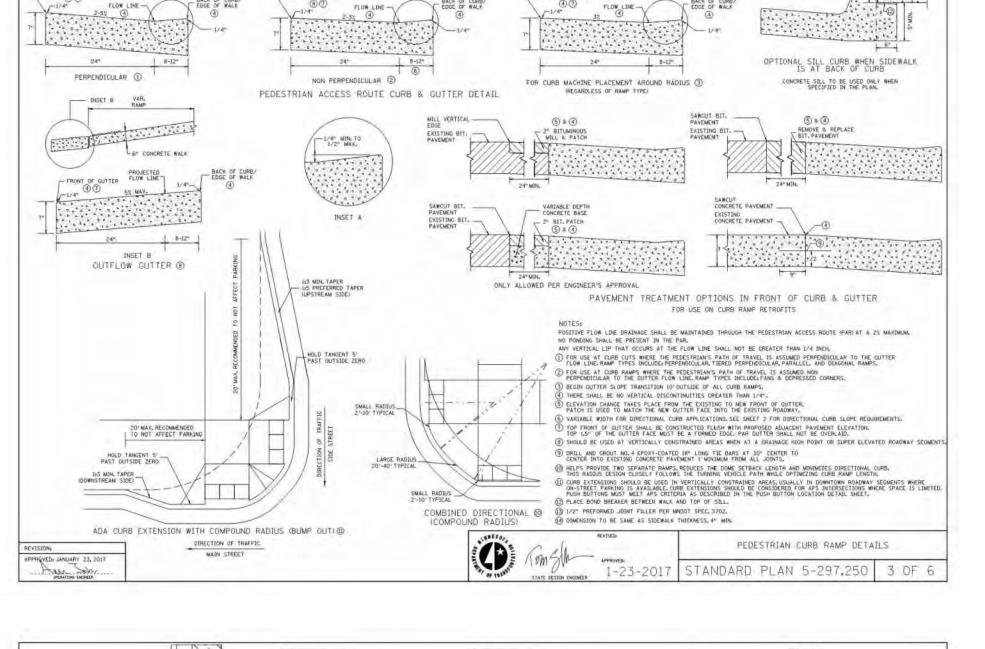

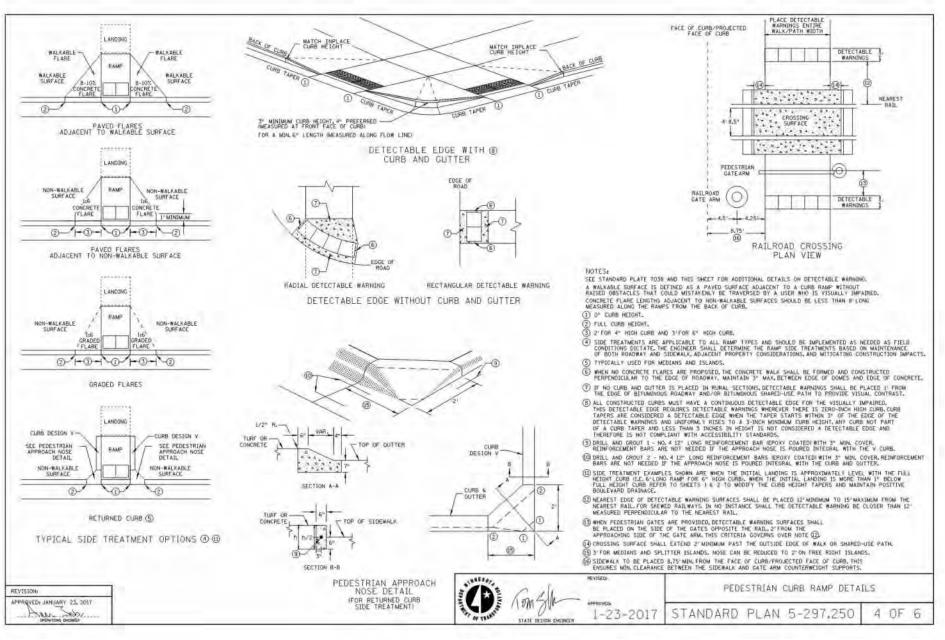

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EAST LAKE STREET, MINNEAPOLIS, MN

S $\overline{\square}$

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SPECIFICATION, OR REPORT WAS
PREPARED BY ME OR UNDER MY DIRECT
SUPERVISION AND THAT I AM A DULY
LICENSED PROFESSIONAL ENGINEER
UNDER THE LAWS OF THE STATE OF
MINNESOTA.

Matthew R. Pavek

DATE 11/02/20 LICENSE NO. 44263

ISSUE/SUBMITTAL SUMMARY

DATE DESCRIPTION

10/08/2020 PDR SUBMITTAL

10/20/20 PDR SUBMITTAL

11/02/20 PDR SUBMITTAL

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PROJECT NUMBER: 20267


REVISION SUMMARY

DATE DESCRIPTION

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CIVIL DETAILS

C5.1

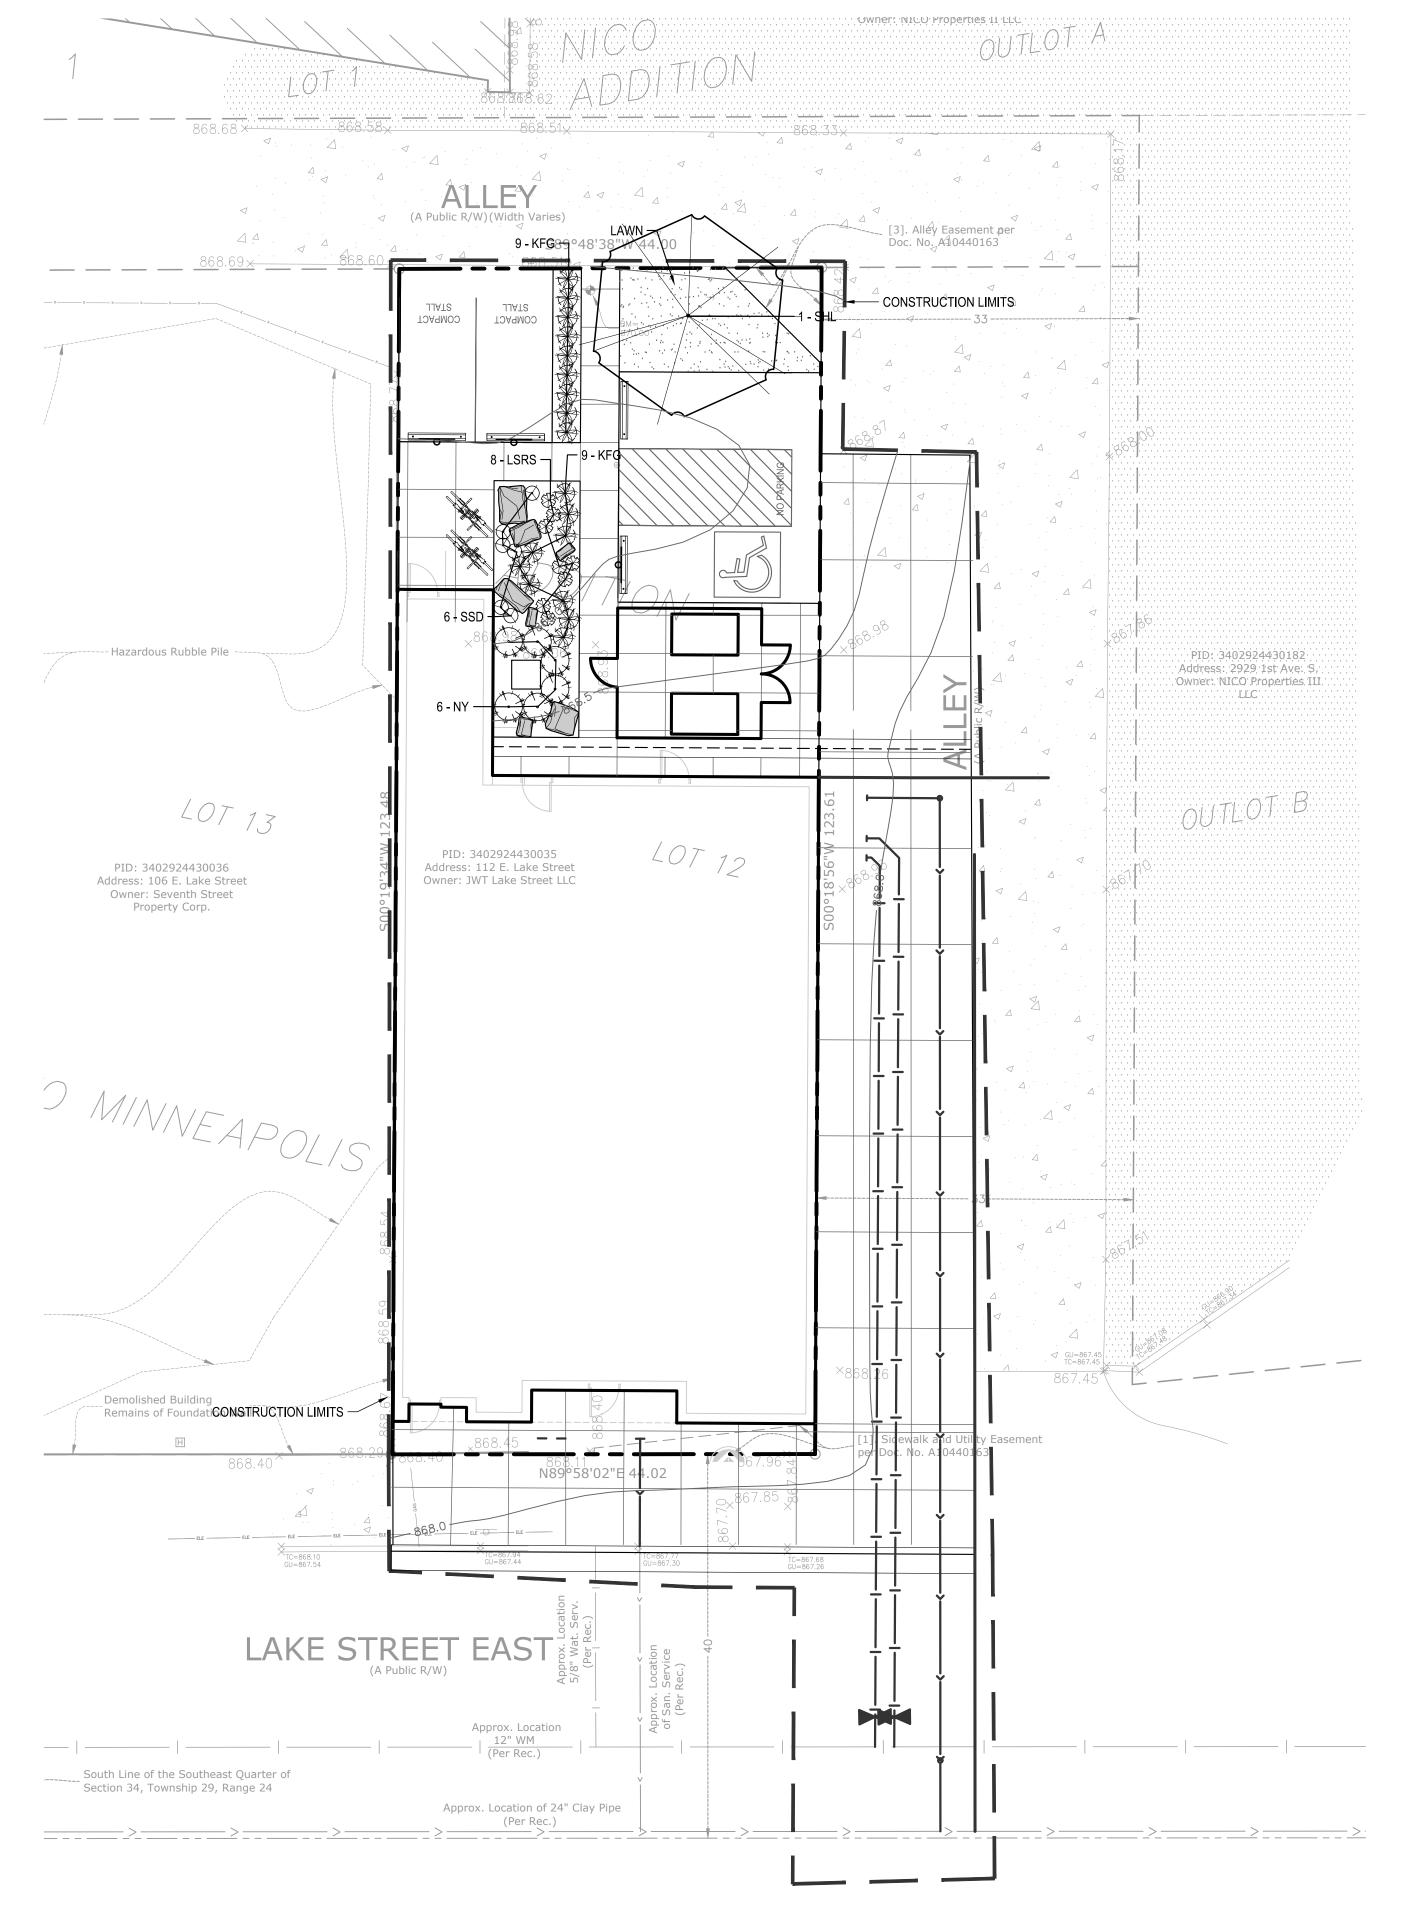

LANDSCAPE NOTES:

- 1. WHERE SHOWN, SHRUB & PERENNIAL BEDS SHALL BE MULCHED WITH 4" DEPTH (MINIMUM AFTER INSTALLATION AND/OR TOP DRESSING OPERATIONS) OF SHREDDED CYPRESS MULCH.
- 2. ALL TREES SHALL BE MULCHED WITH SHREDDED CYPRESS MULCH TO OUTER EDGE OF SAUCER OR TO EDGE OF PLANTING BED, IF APPLICABLE. ALL MULCH SHALL BE KEPT WITHIN A MINIMUM OF 2" FROM TREE TRUNK.
- 3. IF SHOWN ON PLAN, RANDOM SIZED LIMESTONE BOULDERS COLOR AND SIZE TO COMPLIMENT NEW LANDSCAPING. OWNER TO APPROVE BOULDER SAMPLES PRIOR TO INSTALLATION.
- 4. PLANT MATERIALS SHALL CONFORM WITH THE AMERICAN ASSOCIATION OF NURSERYMEN STANDARDS AND SHALL BE OF HARDY STOCK, FREE FROM DISEASE, DAMAGE AND DISFIGURATION. CONTRACTOR IS RESPONSIBLE FOR MAINTAINING PLUMPNESS OF PLANT MATERIAL FOR DURATION OF ACCEPTANCE PERIOD.
- 5. UPON DISCOVERY OF A DISCREPANCY BETWEEN THE QUANTITY OF PLANTS SHOWN ON THE SCHEDULE AND THE QUANTITY SHOWN ON THE PLAN, THE PLAN SHALL GOVERN.
- 6. CONDITION OF VEGETATION SHALL BE MONITORED BY THE LANDSCAPE ARCHITECT THROUGHOUT THE DURATION OF THE CONTRACT. LANDSCAPE MATERIALS PART OF THE CONTRACT SHALL BE WARRANTED FOR ONE (1) FULL GROWING SEASONS FROM SUBSTANTIAL COMPLETION DATE.
- 7. ALL AREAS DISTURBED BY CONSTRUCTION ACTIVITIES SHALL RECEIVE 4" LAYER TOPSOIL AND SOD AS SPECIFIED UNLESS OTHERWISE NOTED ON THE DRAWINGS.
- 8. COORDINATE LOCATION OF VEGETATION WITH UNDERGROUND AND OVERHEAD UTILITIES, LIGHTING FIXTURES, DOORS AND WINDOWS. CONTRACTOR SHALL STAKE IN THE FIELD FINAL LOCATION OF TREES AND SHRUBS FOR REVIEW AND APPROVAL BY THE LANDSCAPE ARCHITECT PRIOR TO INSTALLATION.
- 9. ALL PLANT MATERIALS SHALL BE WATERED AND MAINTAINED UNTIL ACCEPTANCE.
- 10. REPAIR AT NO COST TO OWNER ALL DAMAGE RESULTING FROM LANDSCAPE CONTRACTOR'S ACTIVITIES.
- SWEEP AND MAINTAIN ALL PAVED SURFACES FREE OF DEBRIS GENERATED FROM LANDSCAPE CONTRACTOR'S ACTIVITIES.
- 12. REPAIR AT NO COST TO THE OWNER IRRIGATION SYSTEM DAMAGED FROM LANDSCAPE CONSTRUCTION ACTIVITIES.
- 13. PROVIDE SITE WIDE IRRIGATION SYSTEM DESIGN AND INSTALLATION. SYSTEM SHALL BE FULLY PROGRAMMABLE AND CAPABLE OF ALTERNATE DATE WATERING. THE SYSTEM SHALL PROVIDE HEAD TO HEAD OR DRIP COVERAGE AND BE CAPABLE OF DELIVERING ONE INCH OF PRECIPITATION PER WEEK. SYSTEM SHALL EXTEND INTO THE PUBLIC RIGHT-OF-WAY TO THE EDGE OF PAVEMENT/BACK OF CURB.
- 14. CONTRACTOR SHALL SECURE APPROVAL OF PROPOSED IRRIGATION SYSTEM INLCUDING PRICING FROM OWNER, PRIOR TO INSTALLATION.

PLANT SCHEDULE - ENTIRE SITE

SYM	QUANT.	COMMON NAME	BOTANICAL NAME	SIZE	ROOT	POLLINATOR FRIENDLY	NATIVE	COMMENTS
-		DECIDUOUS TREES						
SHL	1	SKYLINE HONEYLOCUST	Gleditsia triacanthos 'Skycole'	2.5" CAL.	B&B			STRAIGHT LEADER. FULL FORM
		SHRUBS - CONIFEROUS & EVERGREEN						
NY	6	NOVA YEW	Taxus cuspidata 'Nova'	36" HT.	CONT.			
		PERENNIALS/ORNAMENTAL GRASSES						
KFG	18	KARL FOERSTER FEATHER REED GRASS	Calamagrostis x acutiflora 'Karl Foerster'	#1	CONT.			
LSRS	8	LITTLE SPIRE RUSSIAN SAGE	Perovskia 'Little Spire'	#1	CONT.	Х		
SSD	6	STELLA SUPREME DAYLILY	Hemerocallis 'Stella Supreme'	#1	CONT.	Χ	Х	

LANDSCAPE CALCULATIONS:

PROPOSED LANDSCAPE AREA CALCULATION: SITE AREA - BUILDING COVERAGE = OPEN SPACE 5,437.0 SF - 3,319.0 SF = 2,118.0 SF 20% OF OPEN SPACE = LANDSCAPE AREA 423.6 SF REQUIRED 2,118.0 SF = 465.0 SF PROVIDED 22% X 2,118.0 SF = PROPOSED IMPERVIOUS RATIO PROPOSED LANDSCAPE: 1 TREE/ 500 SF OF "LANDSCAPE AREA" 423.6 SF / 500 = 1 TREES REQUIRED SEE PLANT SCHEDULE 1 SHRUB/100 SF OR "LANDSCAPE AREA" 423.6 SF / 100 = 4.2 SHRUBS REQUIRED

SEE PLANT SCHEDULE

CITY OF MINNEAPOLIS SITE SPECIFIC LANDSCAPE NOTES:

1. ALL PROPOSED TREES IN THE PUBLIC RIGHT-OF-WAY ARE SUBJECT TO THE REVIEW AND APPROVAL OF THE MINNEAPOLIS PARK BOARD. PLEASE CONTACT CRAIG PINKALLA AT (612) 499-9233 TO DISCUSS TREE SPECIES SELECTION, PLANTING METHOD, SPACING AND LOCATIONS. TREE PLANTING DETAILS SHALL BE INCLUDED IN THE PLANS. FOR ALL TREES PROPOSED IN "HARDSCAPE ENVIRONMENTS" WITHIN THE PUBLIC RIGHT-OF- WAY,

PIT FOR ALL PROPOSED STREET TREES. LANDSCAPING IN THE PUBLIC RIGHT-OF-WAY SHALL FOLLOW

ESTABLISHED DESIGN STANDARDS IN ACCORDANCE WITH THE CITY OF MINNEAPOLIS STANDARD

THE FOLLOWING:HTTP://WWW.MINNEAPOLISMN.GOV/PUBLICWORKS/PLATES/INDEX.HTM).

THE APPLICANT SHALL PROVIDE ENGINEERED/STRUCTURED SOIL IN THE FORM OF A TREE TRENCH OR TREE

SUPPLEMENTAL SPECIFICATIONS FOR CONSTRUCTION CURRENT EDITION AND ITS ATTACHMENTS (REFER TO


POLLINATOR SAFE PLANT MATERIAL:


- 1. THE CONTRACTOR SHALL PROVIDE ONLY PLANT MATERIAL FREE OF NEONICOTINOID BASED INSECTICIDES AND/OR TREATMENTS OF ANY KIND, INCLUDING BY NOT LIMITED TO IMIDACLOPRID (CONFIDOR, ADMIRE, GAUCHO, ADVOCATE), THIAMETHOXAM (ACTARA, PLATINUM, CRUISER), CLOTHIANIDIN (PONCHO, DANTOSU, DANTOP), ACETAMIPRID (MOSPILAN, ASSAIL, CHIPCOTRISTAR), THIACLOPRID (CALYPSO), DINOTEFURAN (STARKLE, SAFARI, VENOM), AND NITENPYRAM (CAPSTAR, GUARDIAN).
- 2. CONTRACTOR SHALL CERTIFY, THROUGH SUPPLIERS POLICY STATEMENT OR AFFIDAVIT. THAT NO NEONICOTINOID BASED INSECTICIDES HAVE BEEN USED ON SITE OR DIRECTLY ADJACENT TO THE GROWING OR STORAGE PLOTS OF THE SUPPLIED PLANT MATERIAL, INCLUDING THE PLANTING OF AGRICULTURAL (OR OTHER) SEED TREATED WITH NEONICS..

LANDSCAPE LEGEND


PLANTING BEDS & TREE RINGS - SHREDDED CEDAR MULCH, SAMPLES REQUIRED, PROVIDE EDGING AS SHOWN ON PLAN

1" DIA. ROCK MAINTENANCE STRIP OVER FILTER FABRIC,
SAMPLES REQUIRED. PROVIDE EDGING AS SHOWN ON PLAN

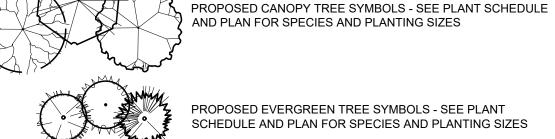


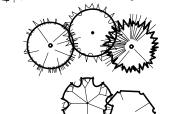

PROPOSED EVERGREEN TREE SYMBOLS - SEE PLANT SCHEDULE AND PLAN FOR SPECIES AND PLANTING SIZES

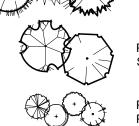

PROPOSED ORNAMENTAL TREE SYMBOLS - SEE PLANT SCHEDULE AND PLAN FOR SPECIES AND PLANTING SIZES

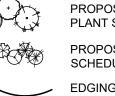


PROPOSED DECIDUOUS AND EVERGREEN SHRUB SYMBOLS - SEE PLANT SCHEDULE AND PLAN FOR SPECIES AND PLANTING SIZES PROPOSED PERENNIAL PLANT SYMBOLS - SEE PLANT SCHEDULE AND PLAN FOR SPECIES AND PLANTING SIZES



DECORATIVE BOULDERS (ROUNDED & BLOCK STYLE), 18"-30" DIA.



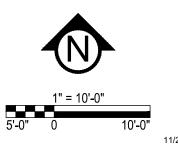

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DATE 11/02/20 LICENSE NO. 24904


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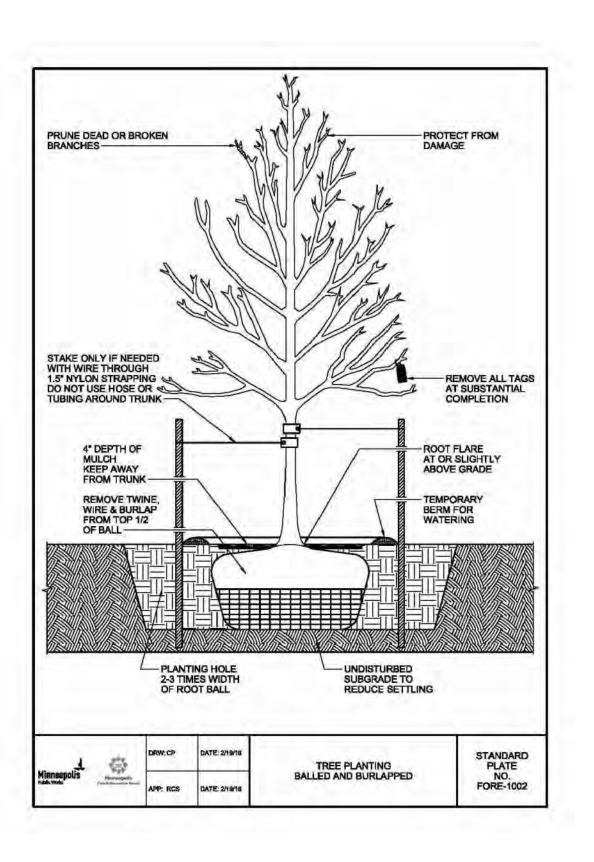
10/08/2020 PDR SUBMITTAL 10/20/20 PDR SUBMITTAL 11/02/20 PDR SUBMITTAL

DRAWN BY:KB, KW REVIEWED BY: MP PROJECT NUMBER: 20267

REVISION SUMMARY DATE DESCRIPTION


LANDSCAPE PLAN



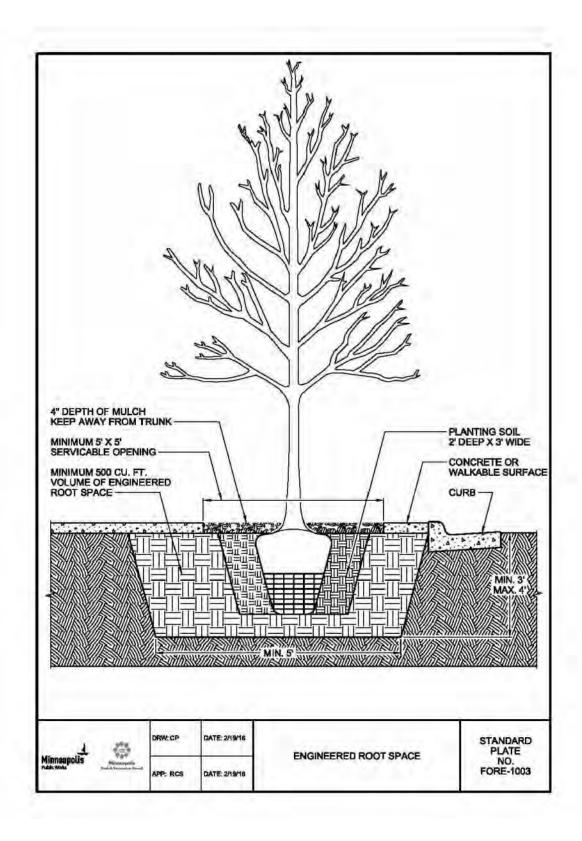

IRRIGATION NOTES:

- 1. ENTIRE SITE SHALL BE FULLY IRRIGATED. THE CONTRACTOR SHALL SUBMIT IRRIGATION SHOP DRAWINGS FOR REVIEW AND APPROVAL BY THE LANDSCAPE ARCHITECT PRIOR TO INSTALLATION.
- 2. SEE MECHANICAL AND ELECTRICAL PLANS AND SPECIFICATIONS FOR IRRIGATION WATER, METER, AND POWER CONNECTIONS.
- 3. CONTRACTOR TO VERIFY LOCATION OF ALL UNDERGROUND/ABOVE GROUND FACILITIES PRIOR TO ANY EXCAVATION/INSTALLATION. ANY DAMAGE TO UNDERGROUND/ABOVE GROUND FACILITIES SHALL BE THE RESPONSIBILITY OF
- THE CONTRACTOR AND COSTS ASSOCIATED WITH CORRECTING DAMAGES SHALL BE BORNE ENTIRELY BY THE CONTRACTOR. 4. SERVICE EQUIPMENT AND INSTALLATION SHALL BE PER LOCAL UTILITY COMPANY STANDARDS AND SHALL BE PER NATIONAL AND LOCAL CODES. EXACT LOCATION OF SERVICE EQUIPMENT SHALL BE COORDINATED WITH THE LANDSCAPE ARCHITECT
- OR EQUIVALENT AT THE JOB SITE. 5. CONTRACTOR SHALL COORDINATE WITH LOCAL UTILITY COMPANY FOR THE PROPOSED ELECTRICAL SERVICE AND METERING FACILITIES.
- 6. IRRIGATION WATER LINE CONNECTION SIZE IS 1-½" AT BUILDING. VERIFY WITH MECHANICAL PLANS.COVAGE.
- 7. ALL MAIN LINES SHALL BE 18" BELOW FINISHED GRADE.
- 8. ALL LATERAL LINES SHALL BE 12" BELLOW FINISHED GRADE.
- 9. ALL EXPOSED PVC RISERS, IF ANY, SHALL BE GRAY IN COLOR.
- 10. CONTRACTOR SHALL LAY ALL SLEEVES AND CONDUIT AT 2'-0" BELOW THE FINISHED GRADE OF THE TOP OF PAVEMENT. EXTEND SLEEVES TO 2'-0" BEYOND PAVEMENT.
- 11. CONTRACTOR SHALL MARK THE LOCATION OF ALL SLEEVES AND CONDUIT WITH THE SLEEVING MATERIAL "ELLED" TO 2'-0" ABOVE FINISHED GRADE AND CAPPED.
- 12. FABRICATE ALL PIPE TO MANUFACTURE'S SPECIFICATIONS WITH CLEAN AND SQUARE CUT JOINTS. USE QUALITY GRADE PRIMER AND SOLVENT CEMENT FORMULATED FOR INTENDED TYPE OF CONNECTION.
- 13. BACKFILL ALL TRENCHES WITH SOIL FREE OF SHARP OBJECTS AND DEBRIS.
- 14. ALL VALVE BOXES AND COVERS SHALL BE BLACK IN COLOR.
- 15. GROUP VALVE BOXES TOGETHER FOR EASE WHEN SERVICE IS REQUIRED. LOCATE IN PLANT BED AREAS WHENEVER POSSIBLE.
- 16. IRRIGATION CONTROLLER LOCATION SHALL BE VERIFIED ON-SITE WITH OWNER'S REPRESENTATIVE.
- 17. CONTROL WIRES: 14 GAUGE DIRECT BURIAL, SOLID COPPER IRRIGATION WIRE. RUN UNDER MAIN LINE. USE MOISTURE-PROOF SPLICES AND SPLICE ONLY AT VALVES OR PULL BOXES. RUN SEPARATE HOT AND COMMON WIRE TO EACH VALVE AND ONE (1) SPARE WIRE AND GROUND TO FURTHEST VALVE FROM CONTROLLER. LABEL OR COLOR CODE ALL WIRES.
- 18. AVOID OVER SPRAY ON BUILDINGS, PAVEMENT, WALLS AND ROADWAYS BY INDIVIDUALLY ADJUSTING RADIUS OR ARC ON SPRINKLER HEADS AND FLOW CONTROL ON AUTOMATIC VALVE.
- 19. ADJUST PRESSURE REGULATING VALVES FOR OPTIMUM PRESSURE ON SITE.
- 20. USE SCREENS ON ALL HEADS.
- 21. A SET OF AS-BUILT DRAWINGS SHALL BE MAINTAINED ON-SITE AT ALL TIMES IN AN UPDATED CONDITION.
- 22. ALL PIPE 3" AND OVER SHALL HAVE THRUST BLOCKING AT EACH TURN.
- 23. ALL AUTOMATIC REMOTE CONTROL VALVES WILL HAVE 3" MINIMUM DEPTH OF 3/4" WASHED GRAVEL UNDERNEATH VALVE AND VALVE BOX. GRAVEL SHALL EXTENT 3" BEYOND PERIMETER OF VALVE BOX.
- 24. THERE SHALL BE 3" MINIMUM SPACE BETWEEN BOTTOM OF VALVE BOX COVER AND TOP OF VALVE STRUCTURE.

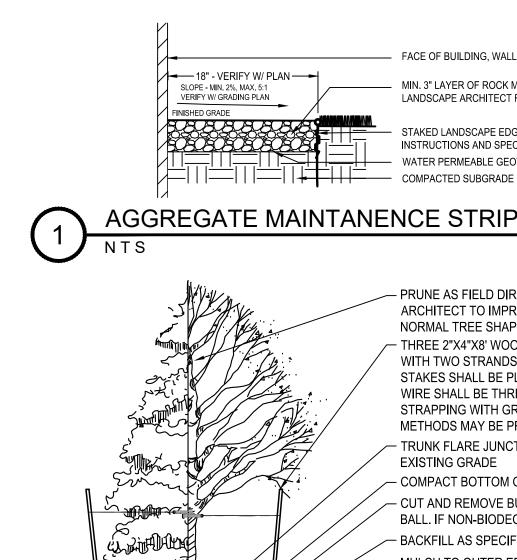


FACE OF BUILDING, WALL, OR STRUCTURE


MIN. 3" LAYER OF ROCK MULCH AS SPECIFIED. PROVIDE SAMPLE TO LANDSCAPE ARCHITECT FOR APPROVAL PRIOR TO INSTALLATION

STAKED LANDSCAPE EDGER AS SPECIFIED, SEE MANUFACTURER'S INSTRUCTIONS AND SPECS. FOR INSTALLATION AND PLACEMENT WATER PERMEABLE GEOTEXTILE FABRIC AS SPECIFIED

AGGREGATE MAINTANENCE STRIP

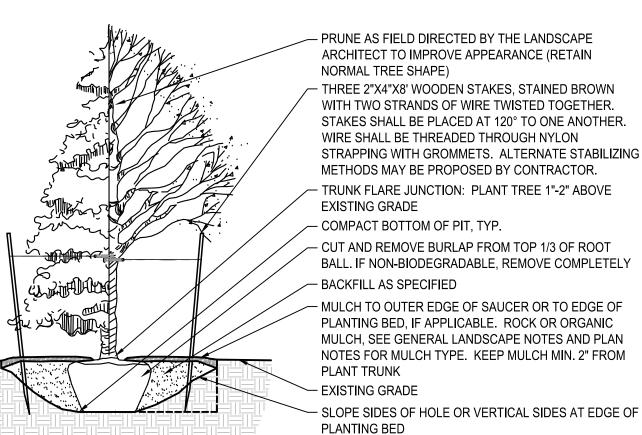

OR OVERALL PLANT PLACEMENT OF ROOTBALL DECIDUOUS & CONIFEROUS TREE PLANTING

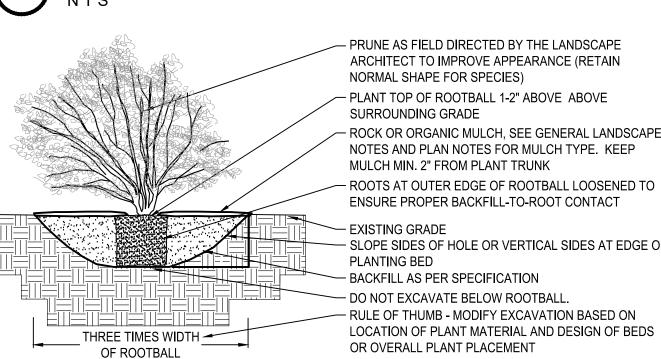

- PRUNE AS FIELD DIRECTED BY THE LANDSCAPE ARCHITECT TO IMPROVE APPEARANCE (RETAIN NORMAL SHAPE FOR SPECIES)


- RULE OF THUMB - MODIFY EXCAVATION BASED ON LOCATION OF PLANT MATERIAL AND DESIGN OF BEDS

— PLANT TOP OF ROOTBALL 1-2" ABOVE ABOVE SURROUNDING GRADE - ROCK OR ORGANIC MULCH, SEE GENERAL LANDSCAPE NOTES AND PLAN NOTES FOR MULCH TYPE. KEEP MULCH MIN. 2" FROM PLANT TRUNK

ENSURE PROPER BACKFILL-TO-ROOT CONTACT EXISTING GRADE - SLOPE SIDES OF HOLE OR VERTICAL SIDES AT EDGE OF

PLANTING BED BACKFILL AS PER SPECIFICATION DO NOT EXCAVATE BELOW ROOTBALL. - RULE OF THUMB - MODIFY EXCAVATION BASED ON LOCATION OF PLANT MATERIAL AND DESIGN OF BEDS OR OVERALL PLANT PLACEMENT

DECIDUOUS & CONIFEROUS SHRUB PLANTING

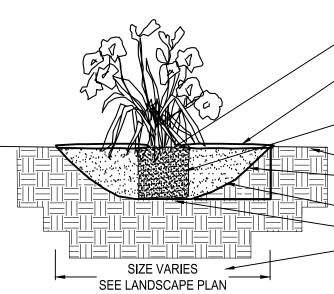

- PLANT TOP OF ROOTBALL 1-2" ABOVE ABOVE SURROUNDING GRADE

- ROCK OR ORGANIC MULCH, SEE GENERAL LANDSCAPE NOTES AND PLAN NOTES FOR MULCH TYPE. KEEP MULCH MIN. 2" FROM PLANT STEM - ROOTS AT OUTER EDGE OF ROOTBALL LOOSENED TO ENSURE PROPER BACKFILL-TO-ROOT CONTACT

- EXISTING GRADE - SLOPE SIDES OF HOLE OR VERTICAL SIDES AT EDGE OF PLANTING BED

- BACKFILL AS PER SPECIFICATION DO NOT EXCAVATE BELOW ROOTBALL. - MODIFY EXCAVATION BASED ON LOCATION OF PLANT MATERIAL AND DESIGN OF BEDS OR OVERALL PLANT PLACEMENT

PERENNIAL BED PLANTING

Know what's **below**.

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THE LAWS OF THE STATE OF MINNESOTA

DATE 11/02/20 LICENSE NO. 24904

ISSUE/SUBMITTAL SUMMARY DATE DESCRIPTION

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DRAWN BY:KB, KW REVIEWED BY: MP PROJECT NUMBER: 20267


REVISION SUMMARY DATE DESCRIPTION

LANDSCAPE PLAN

NOTES & DETAILS

11/2/2020 1:04 PM

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SWPPP NOTES:

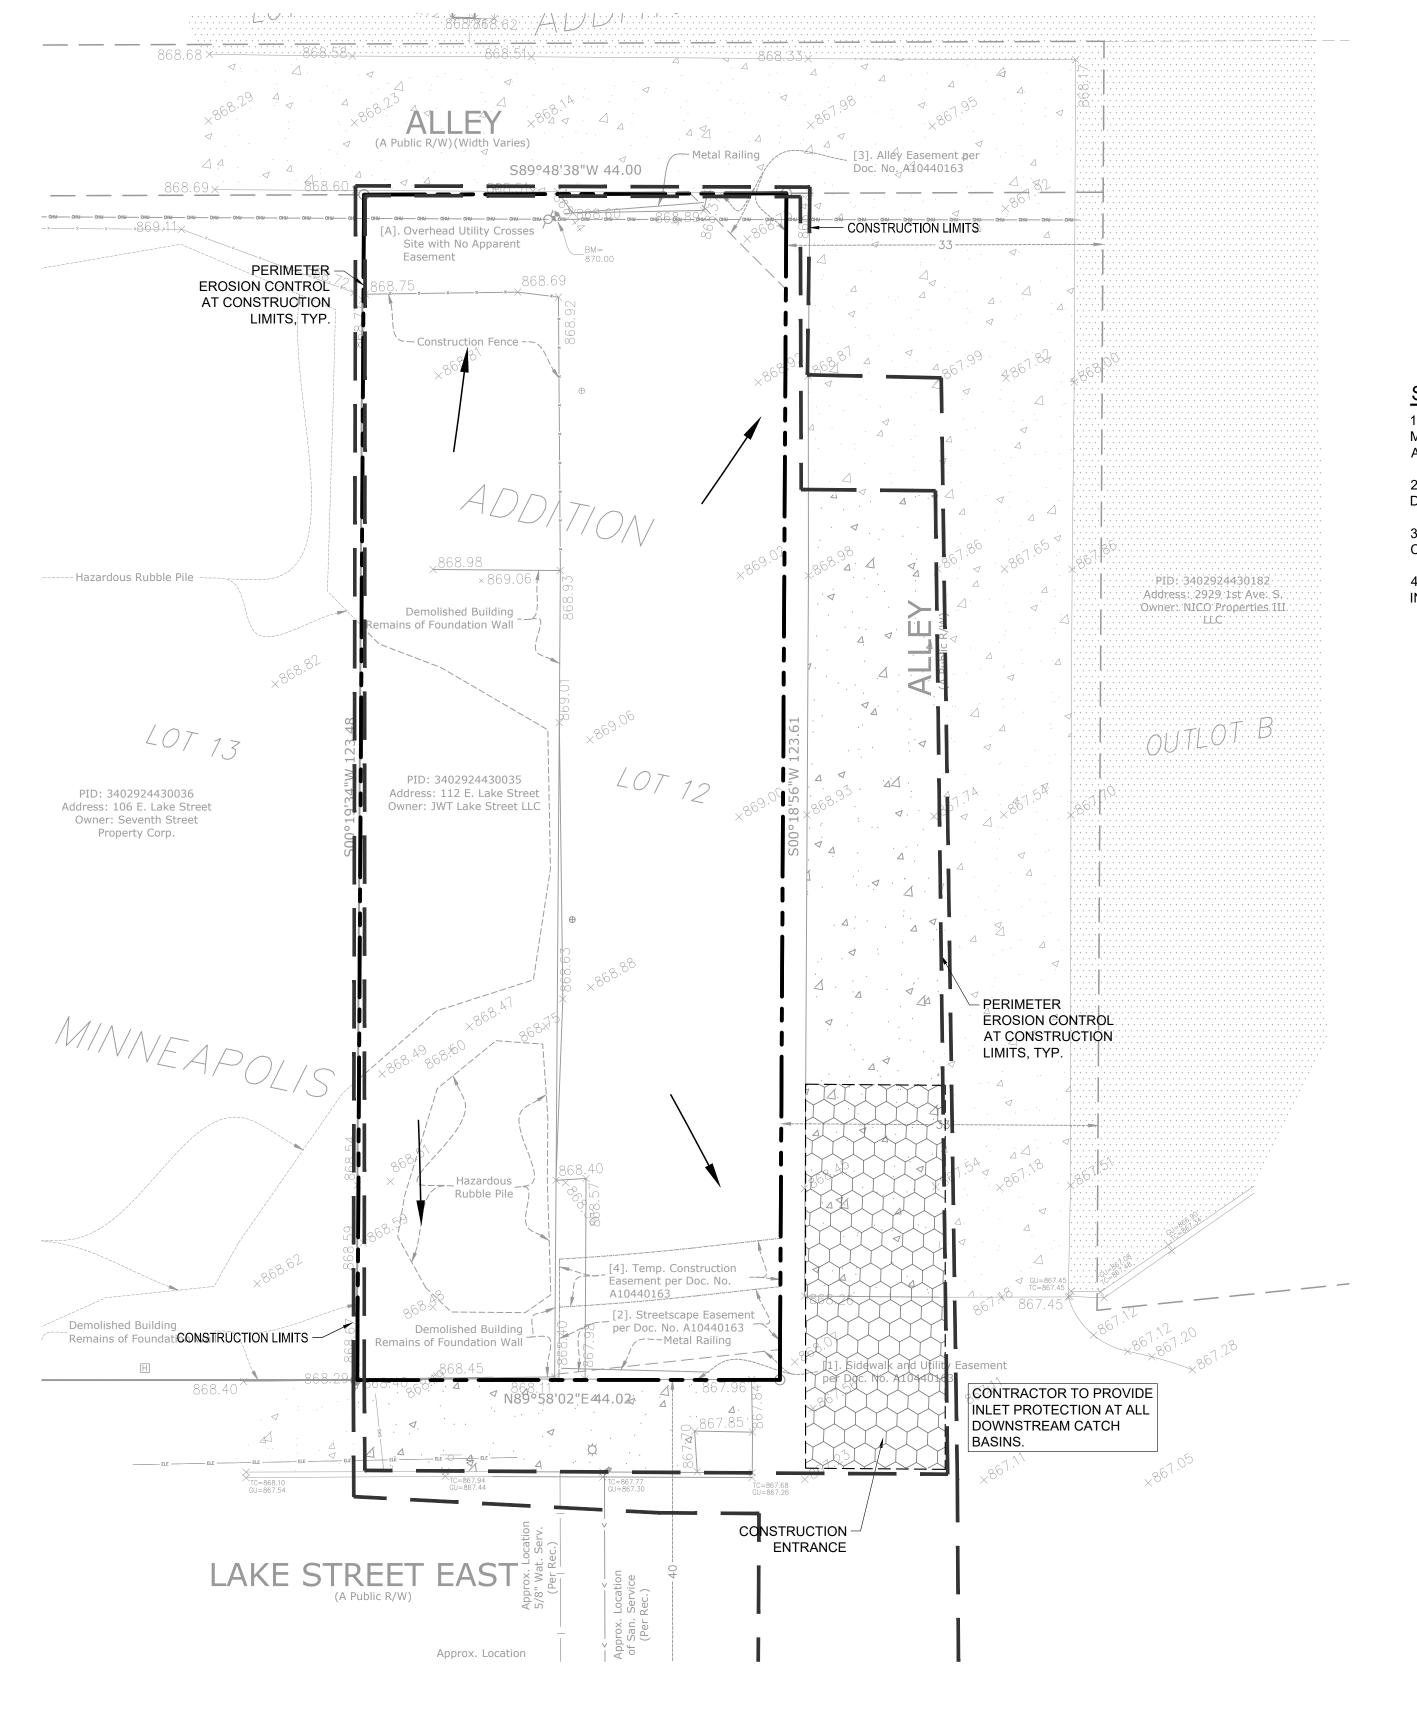1. THIS PROJECT IS LESS THAN ONE ACRE AND WILL NOT REQUIRE AN MPCA NPDES PERMIT. CONTRACTOR IS RESPONSIBLE FOR OBTAINING ANY EROSION CONTROL PERMITS REQUIRED BY THE CITY.

- 2. SEE SHEETS SW1.0 SW1.3 FOR ALL EROSION CONTROL NOTES, DESCRIPTIONS, AND PRACTICES.
- 3. SEE GRADING PLAN FOR ADDITIONAL GRADING AND EROSION CONTROL NOTES.
- 4. CONTRACTOR IS RESPONSIBLE FOR SWPPP IMPLEMENTATION, INSPECTIONS, AND COMPLIANCE WITH NPDES PERMIT.

ALL SPECIFIED EROSION AND SEDIMENT CONTROL PRACTICES, AND MEASURES CONTAINED IN THIS SWPPP ARE THE MINIMUM REQUIREMENTS. ADDITIONAL PRACTICES MAY BE REQUIRED DURING THE COURSE OF CONSTRUCTION.

CITY OF MINNEAPOLIS EROSION CONTROL NOTES:

OWNERS AND OPERATORS ARE RESPONSIBLE FOR COMPLYING WITH REGULATIONS AND OBTAINING ANY NECESSARY COVERAGE UNDER THE MPCA'S GENERAL PERMIT TO DISCHARGE STORMWATER ASSOCIATED WITH CONSTRUCTION ACTIVITY (PERMIT NO. MN R100001).

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DATE 11/02/20 LICENSE NO. 44263 ISSUE/SUBMITTAL SUMMARY

DATE DESCRIPTION 10/08/2020 PDR SUBMITTAL 10/20/20 PDR SUBMITTAL 11/02/20 PDR SUBMITTAL

DRAWN BY:KB, KW REVIEWED BY: MP

REVISION SUMMARY

CONDITIONS

PROJECT NUMBER: 20267

DATE DESCRIPTION

EX. 1' CONTOUR ELEVATION INTERVAL 1.0' CONTOUR ELEVATION INTERVAL DRAINAGE ARROW SILT FENCE / BIOROLL - GRADING LIMIT


INLET PROTECTION

LEGEND:


STABILIZED CONSTRUCTION ENTRANCE

EROSION CONTROL BLANKET



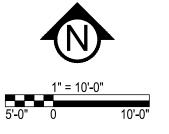



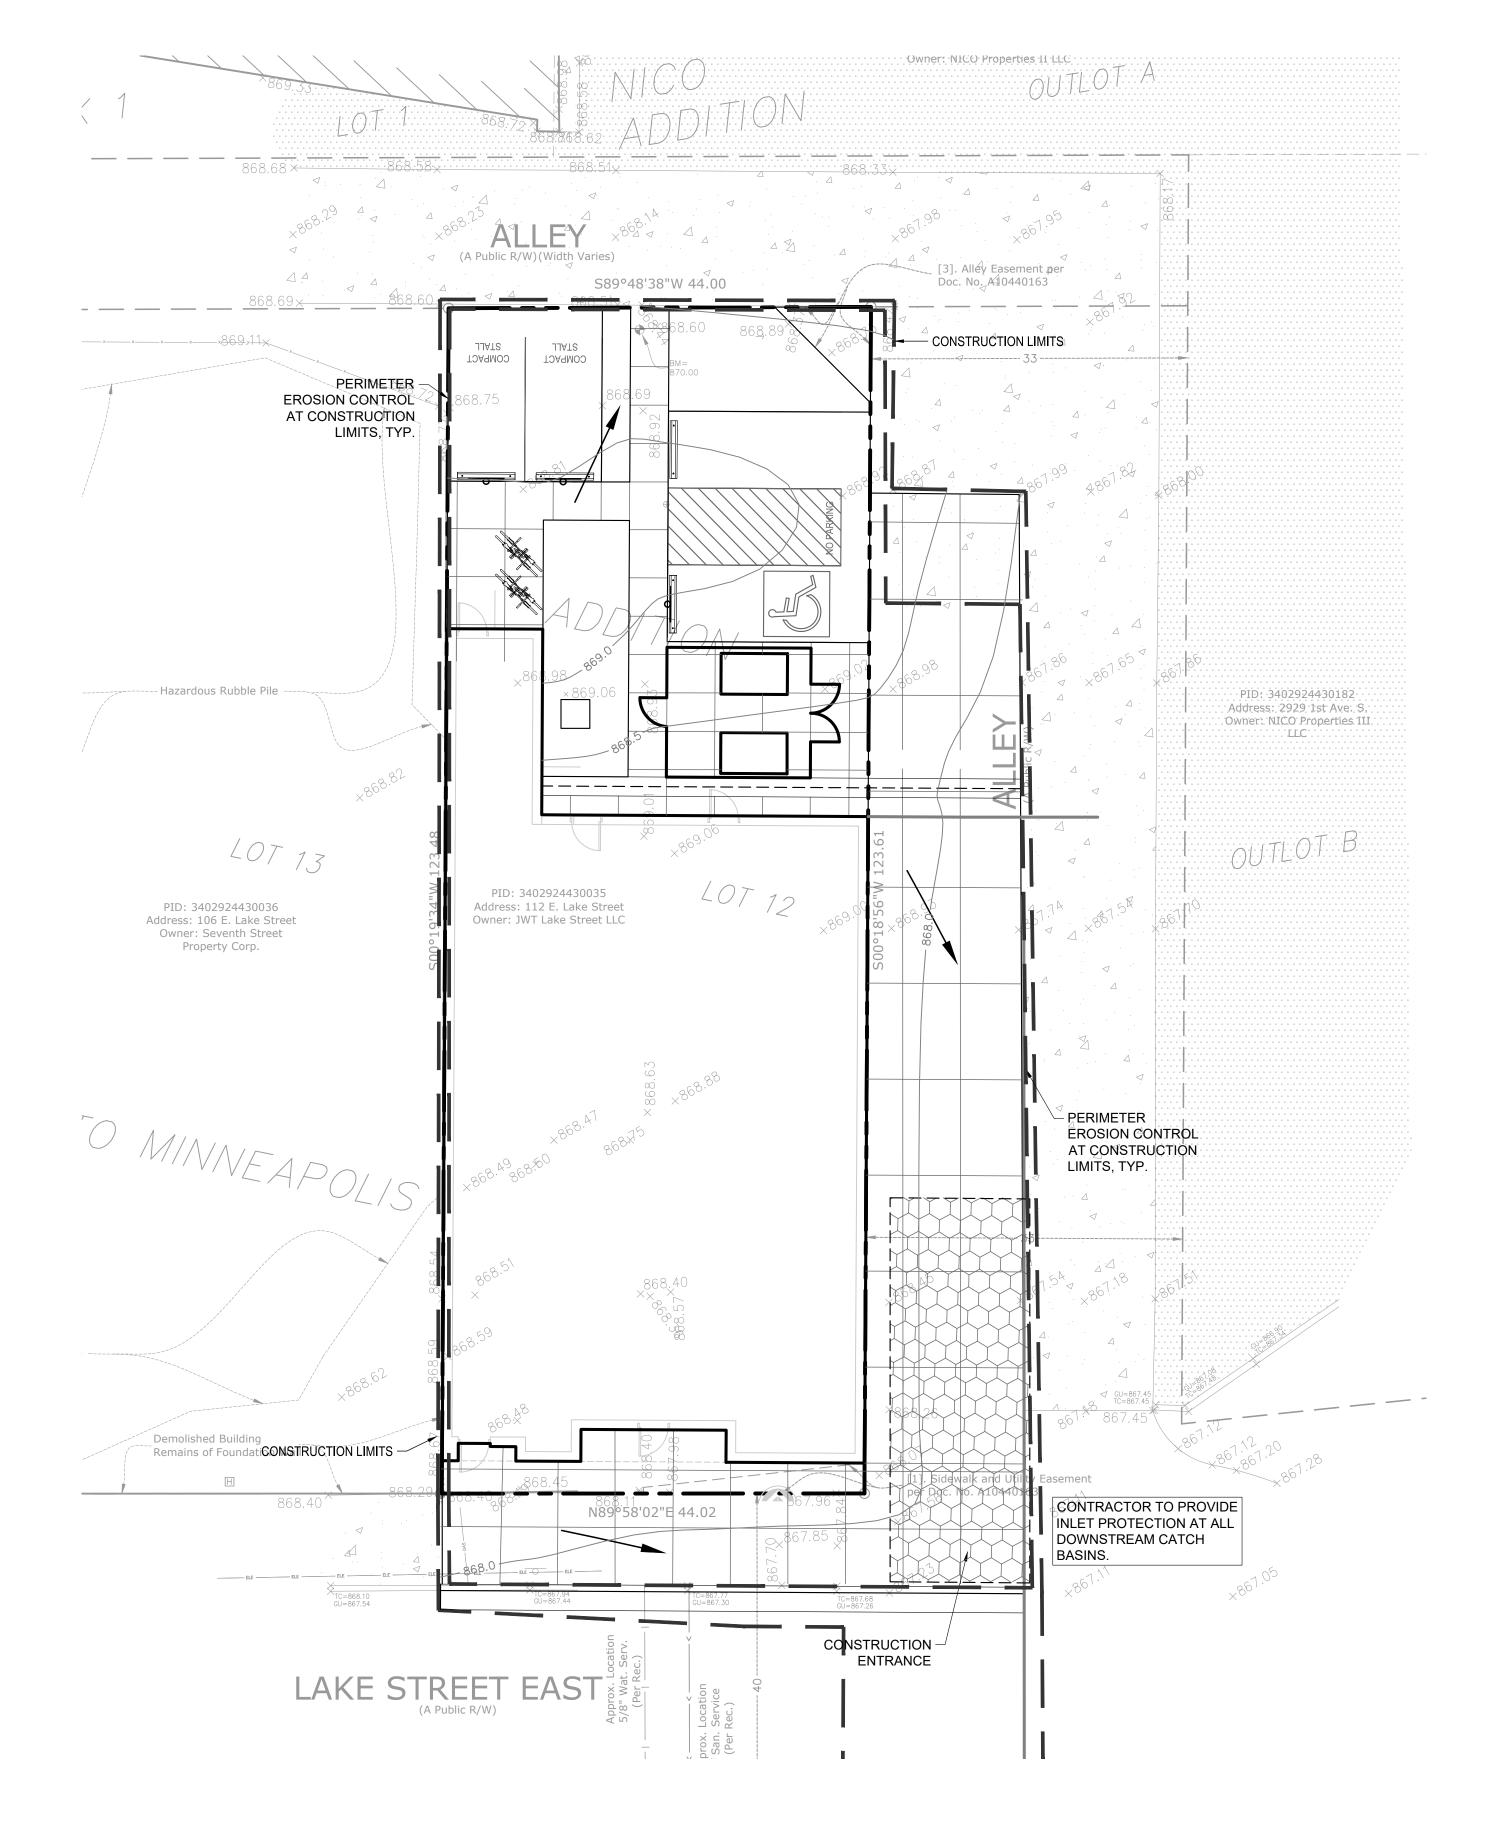

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ISSUE/SUBMITTAL SUMMARY DATE DESCRIPTION 10/08/2020 PDR SUBMITTAL 10/20/20 PDR SUBMITTAL

11/02/20 PDR SUBMITTAL

REVISION SUMMARY

SWPPP - PROPOSED

CONDITIONS

DATE DESCRIPTION

DRAWN BY:KB, KW REVIEWED BY: MP INLET PROTECTION PROJECT NUMBER: 20267

STABILIZED CONSTRUCTION ENTRANCE

----- 1125 ----- EX. 1' CONTOUR ELEVATION INTERVAL 11.0' CONTOUR ELEVATION INTERVAL


SILT FENCE / BIOROLL - GRADING LIMIT


DRAINAGE ARROW


EROSION CONTROL BLANKET



LEGEND:

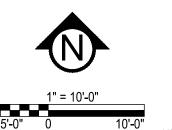


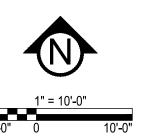

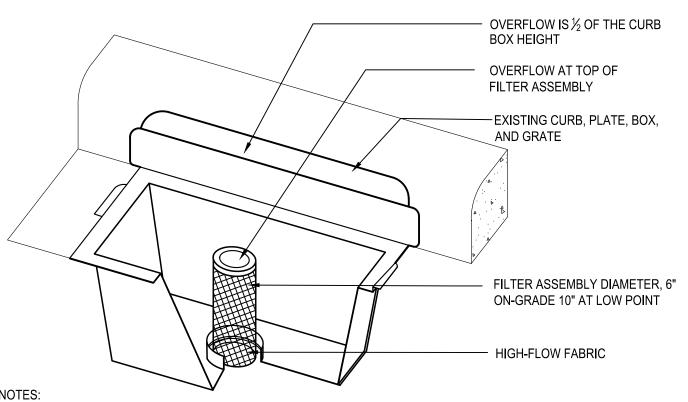

1. REPLACE INLET GRATE UPON COMPLETE INSTALLATION OF INLET PROTECTION FABRIC. 2. CONTRACTOR SHALL REMOVE ALL ACCUMULATED SEDIMENT AND DEBRIS FROM THE SURFACE OF THE SYSTEM AFTER EACH STORM EVENT AND AT THE COMPLETION OF THE CONTRACT.

3. REFERENCE APPLE VALLEY STANDARD PLATE ERO-4C. **CURB INLET FILTER**

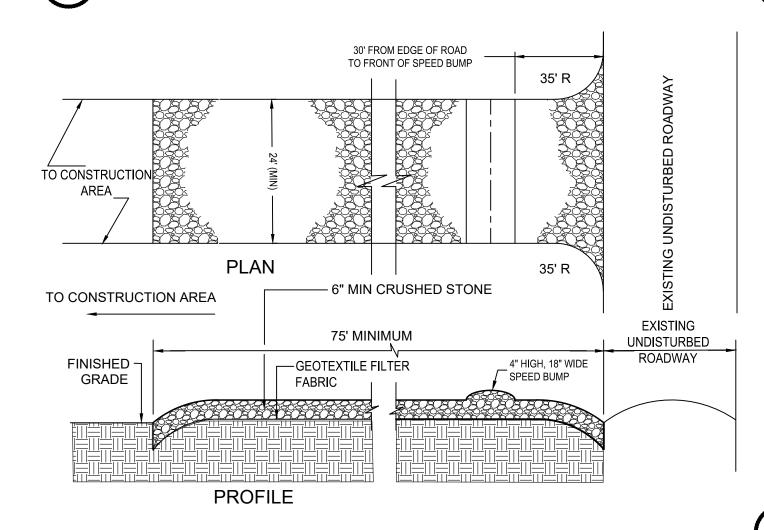

1. PROVIDE APPROPRIATE TRANSITION BETWEEN STABILIZED CONSTRUCTION ENTRANCE AND UNDISTURBED


2. THE ENTRANCE SHALL BE MAINTAINED IN A CONDITION WHICH WILL PREVENT TRACKING OR FLOWING OF SEDIMENT ONTO UNDISTURBED ROADWAY. THIS MAY REQUIRE PERIODIC TOP DRESSING WITH ADDITIONAL STONE OR ADDING

STONE TO THE LENGTH OF THE ENTRANCE. 3. REPAIR AND CLEANOUT MEASURES USED TO TRAP SEDIMENT.

4. ALL SEDIMENT SPILLED, DROPPED, WASHED, OR TRACKED ONTO UNDISTURBED ROADWAY SHALL BE REMOVED AS

5. FINAL LOCATION AND INSTALLATION SHALL BE COORDINATED WITH THE CITY PRIOR TO CONSTRUCTION ACTIVITIES. 6. CRUSHED STONE SHALL BE 1-1/2" DIA. CLOSE GRADED, AND IN ACCORDANCE TO MNDOT SECTION 2118.

2 STABILIZED CONSTRUCTION ACCESS

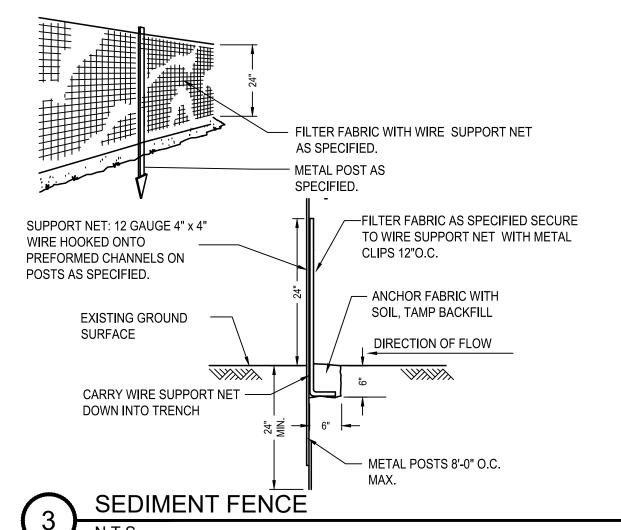

—FILTER FABRIC AS SPECIFIED —FILLER AS SPECIFIED FILL UPSTREAM BASE EDGE WITH 2" OF DIRT OR COMPOST TO EXISTING GROUND SURFACE DIRECTION OF FLOW

> WOODEN STAKES 1/2"X2"X16" MIN. PLACED 10' O.C. WHEN INSTALLED ON GROUND. IF INSTALLED ON PVMT. PROVIDE SANDBAGS BEHIND AND ON TOP AT

1. COMPOST FILTER LOGS (BIO ROLLS) SHALL BE FILTREXX EROSION CONTROL SOXX OR APPROVED EQUAL. 2. COMPOST FILLER TO BE MADE FROM A COMPOST BLEND 30%-40% GRADE 2 (SPEC 3890) AND 60%-70% PARTIALLY DECOMPOSED WOOD CHIPS, PER MNDOT SPEC 3897.

3. FILTER FABRIC SHALL BE GEOTEXTILE KNITTED MATERIAL WITH MAX. OPENINGS OF 3/8". 4. IF MULTIPLE ROLLS NEEDED, OVERLAP BY MIN. 12" AT ENDS AND STAKE.

5. SILT SHALL BE REMOVED ONCE IT REACHES 80% OF THE HEIGHT OF THE ROLL OR AS DEEMED NECESSARY BY SITE CONTRACTOR TO MAINTAIN PROPER FUNCTION.

SEDIMENT BIO-ROLL / COMPOST FILTER LOG

City of Minneapolis Standard Erosion Control Notes



City of Minneapolis Standard Erosion and Sediment Control Notes for Plans These notes may be used as performance standards or requirements for projects not meeting the threshold for a formal plan.

- 1. Contractor must call a construction start 48 hours prior to any land disturbances 612-673-3867. Failure to do so may result in fines, the revocation of permit and a stop work order being issued. 2. Install perimeter erosion control at the locations shown on the plans prior to the commencement of any land
- disturbance or construction activities. 3. Before beginning construction, install a temporary rock construction entrance at each point where vehicles exit the construction site. Use 2 inch or greater diameter rock in a layer at least 6 inches thick across the entire width of
- the entrance. Extend the rock entrance at least 50 feet into the construction zone using a geo-textile fabric beneath the aggregate to prevent migration of soil into the rock from below. 4. Remove all soils and sediments tracked or otherwise deposited onto public and private pavement areas. Removal shall be on a daily basis when tracking occurs and may be ordered by Minneapolis inspectors at any time if conditions warrant. Sweeping shall be maintained throughout the duration of the construction and done in a
- manner to prevent dust being blown to adjacent properties. 5. Install inlet protection at all public and private catch basin inlets, which receive runoff from the disturbed areas. Contractor shall clean, remove sediment or replace storm drain inlet protection devices on a routine basis such that the devices are fully functional for the next rain event. Sediment deposited in and/or plugging drainage systems is the responsibility of the contractor. Hay bales or filter fabric wrapped grates are not allowed for inlet
- 6. Locate soil or dirt stockpiles no less than 25 feet from any public or private roadway or drainage channel. If remaining for more than seven days, stabilize the stockpiles by mulching, vegetative cover, tarps, or other means. Control erosion from all stockpiles by placing silt barriers around the piles. Temporary stockpiles located on paved surfaces must be no less than two feet from the drainage/gutter line and shall be covered if left more than
- 7. Maintain all temporary erosion and sediment control devices in place until the contributing drainage area has been stabilized. Inspect temporary erosion and sediment control devices on a daily basis and replace deteriorated, damaged, or rotted erosion control devices immediately.
- 8. Temporarily or permanently stabilize all construction areas which have undergone final grading, and all areas in which grading or site building construction operations are not actively underway against erosion due to rain, wind and running water within 7-14 days. Use seed and mulch, erosion control matting, and/or sodding and staking in green space areas. Remove all temporary synthetic, structural, non-biodegradable erosion and sediment control devices after the site has undergone final stabilization with permanent vegetation establishment. Final stabilization for purposes of this removal is 70% established cover over denuded area.
- 9. Ready mixed concrete and concrete batch/mix plants are prohibited within the public right of way. All concrete related production, cleaning and mixing activities shall be done in the designated *concrete mixing/washout* locations as shown in the erosion control plan. Under no circumstance may washout water drain onto the public right of way or into any public or private storm drain conveyance.
- 10. Changes to approved erosion control plan must be approved by the erosion control inspector prior to implementation. Contractor to provide installation and details for all proposed alternate type devices.
- 11. If dewatering or pumping of water is necessary, the contractor is responsible for obtaining any necessary permits and/or approvals prior to discharge of any water from the site. If the discharge from the dewatering or pumping process is turbid or contains sediment laden water, it must be treated through the use of sediment traps, vegetative filter strips, or other sediment reducing measures such that the discharge is not visibly different from the receiving water. Additional erosion control measures may be required at the discharge point to prevent scour erosion. The contractor shall provide a dewatering/pumping plan to the Erosion Control Inspector prior to initiating dewatering

PREPARED BY: THE CITY OF MINNEAPOLIS PUBLIC WORKS SURFACE WATER AND SEWERS WWW.CI.MINNEAPOLIS.MN.US/STORMWATER JANUARY 7, 2011

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civilsitegroup.com

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I HEREBY CERTIFY THAT THIS PLAN, SPECIFICATION, OR REPORT WAS PREPARED BY ME OR UNDER MY DIRECT SUPERVISION AND THAT I AM A DULY LICENSED PROFESSIONAL ENGINEER UNDER THE LAWS OF THE STATE OF

Matthew R. Pavek

DATE 11/02/20 LICENSE NO. 44263 ISSUE/SUBMITTAL SUMMARY

DATE	DESCRIPTION
10/08/2020	PDR SUBMITTAL
10/20/20	PDR SUBMITTAL
11/02/20	PDR SUBMITTAL

DRAWN BY:KB, KW REVIEWED BY: MP PROJECT NUMBER: 20267

REVISION SUMMARY DATE DESCRIPTION

SWPPP - DETAILS

STORMWATER DISCHARGE DESIGN REQUIREMENTS

THE NATURE OF THIS PROJECT WILL BE CONSISTENT WITH WHAT IS REPRESENTED IN THIS SET OF CONSTRUCTION PLANS AND SPECIFICATIONS. SEE THE SWPPP PLAN SHEETS AND SWPPP NARRATIVE (ATTACHMENT A: CONSTRUCTION SWPPP TEMPLATE) FOR ADDITIONAL SITE SPECIFIC SWPPP INFORMATION. THE PLANS SHOW LOCATIONS AND TYPES OF ALL TEMPORARY AND PERMANENT EROSION PREVENTION AND SEDIMENT CONTROL BMP'S. STANDARD DETAILS ARE ATTACHED TO THIS SWPPP

THE INTENDED SEQUENCING OF MAJOR CONSTRUCTION ACTIVITIES IS AS FOLLOWS:

- 1. INSTALL STABILIZED ROCK CONSTRUCTION ENTRANCE 2. INSTALLATION OF SILT FENCE AROUND SITE
- 3. INSTALL ORANGE CONSTRUCTION FENCING AROUND INFILTRATION AREAS.
- 4. CLEAR AND GRUB FOR TEMPORARY SEDIMENT BASIN / POND INSTALL
- 5. CONSTRUCT TEMPORARY SEDIMENT BASIN / POND (SECTION 14) 6. CLEAR AND GRUB REMAINDER OF SITE
- 7. STRIP AND STOCKPILE TOPSOIL
- 8. ROUGH GRADING OF SITE 9. STABILIZE DENUDED AREAS AND STOCKPILES
- 10. INSTALL SANITARY SEWER. WATER MAIN STORM SEWER AND SERVICES
- 11. INSTALL SILT FENCE / INLET PROTECTION AROUND CB'S
- 12. INSTALL STREET SECTION
- 13. INSTALL CURB AND GUTTER 14. BITUMINOUS ON STREETS
- 15. FINAL GRADE BOULEVARD, INSTALL SEED AND MULCH
- 16. REMOVE ACCUMULATED SEDIMENT FROM BASIN / POND 17. FINAL GRADE POND / INFILTRATION BASINS (DO NOT COMPACT SOILS IN INFILTRATION AREAS.)
- 18. WHEN ALL CONSTRUCTION ACTIVITY IS COMPLETE AND THE SITE IS STABILIZED BY EITHER SEED OR SOD/LANDSCAPING, REMOVE SILT FENCE AND RESEED ANY AREAS DISTURBED BY THE REMOVAL

RECORDS RETENTION:

THE SWPPP (ORIGINAL OR COPIES) INCLUDING, ALL CHANGES TO IT, AND INSPECTIONS AND MAINTENANCE RECORDS MUST BE KEPT AT THE SITE DURING CONSTRUCTION BY THE PERMITTEE WHO HAS OPERATIONAL CONTROL OF THAT PORTION OF THE SITE. THE SWPPP CAN BE KEPT IN EITHER THE FIELD OFFICE OR IN AN ON SITE VEHICLE DURING NORMAL WORKING HOURS.

ALL OWNER(S) MUST KEEP THE SWPPP, ALONG WITH THE FOLLOWING ADDITIONAL RECORDS, ON FILE FOR THREE (3) YEARS AFTER SUBMITTAL OF THE NOT AS OUTLINED IN SECTION 4. THIS DOES NOT INCLUDE ANY RECORDS AFTER SUBMITTAL OF THE

- THE FINAL SWPPP.
- 2. ANY OTHER STORMWATER RELATED PERMITS REQUIRED FOR THE PROJECT;
- 3. RECORDS OF ALL INSPECTION AND MAINTENANCE CONDUCTED DURING CONSTRUCTION (SEE SECTION 11, INSPECTIONS
- 4. ALL PERMANENT OPERATION AND MAINTENANCE AGREEMENTS THAT HAVE BEEN IMPLEMENTED, INCLUDING ALL RIGHT OF WAY, CONTRACTS, COVENANTS AND OTHER BINDING REQUIREMENTS REGARDING PERPETUAL MAINTENANCE; AND 5. ALL REQUIRED CALCULATIONS FOR DESIGN OF THE TEMPORARY AND PERMANENT STORMWATER MANAGEMENT

SWPPP IMPLEMENTATION RESPONSIBILITIES:

- 1. THE OWNER AND CONTRACTOR ARE PERMITTEE(S) AS IDENTIFIED BY THE NPDES PERMIT.
- 2. CONTRACTOR SHALL BE RESPONSIBLE FOR ALL ON-SITE IMPLEMENTATION OF THE SWPPP, INCLUDING THE ACTIVITIES OF ALL OF THE CONTRACTOR'S SUBCONTRACTORS
- 3. CONTRACTOR SHALL PROVIDE A PERSON(S) KNOWLEDGEABLE AND EXPERIENCED IN THE APPLICATION OF EROSION PREVENTION AND SEDIMENT CONTROL BMPS TO OVERSEE ALL INSTALLATION AND MAINTENANCE OF BMPS AND IMPLEMENTATION OF THE SWPPP.
- 4. CONTRACTOR SHALL PROVIDE PERSON(S) MEETING THE TRAINING REQUIREMENTS OF THE NPDES PERMIT TO CONDUCT INSPECTION AND MAINTENANCE OF ALL EROSION PREVENTION AND SEDIMENT CONTROL BMPS IN ACCORDANCE WITH THE REQUIREMENTS OF THE PERMIT. ONE OF THESE INDIVIDUAL(S) MUST BE AVAILABLE FOR AN ONSITE INSPECTION WITHIN 72 HOURS UPON REQUEST BY MPCA. CONTRACTOR SHALL PROVIDE TRAINING DOCUMENTATION FOR THESE INDIVIDUAL(S) AS REQUIRED BY THE NPDES PERMIT. THIS TRAINING DOCUMENTATION SHALL BE RECORDED IN OR WITH
- THE SWPPP BEFORE THE START OF CONSTRUCTION OR AS SOON AS THE PERSONNEL FOR THE PROJECT HAVE BEEN DETERMINED. DOCUMENTATION SHALL INCLUDE: 4.1. NAMES OF THE PERSONNEL ASSOCIATED WITH THE PROJECT THAT ARE REQUIRED TO BE TRAINED PER SECTION
- 21 OF THE PERMIT.
- 4.2. DATES OF TRAINING AND NAME OF INSTRUCTOR AND ENTITY PROVIDING TRAINING. 4.3. CONTENT OF TRAINING COURSE OR WORKSHOP INCLUDING THE NUMBER OF HOURS OF TRAINING 5. FOLLOWING FINAL STABILIZATION AND THE TERMINATION OF COVERAGE FOR THE NPDES PERMIT, THE OWNER IS EXPECTED TO FURNISH LONG TERM OPERATION AND MAINTENANCE (O & M) OF THE PERMANENT STORM WATER

CONSTRUCTION ACTIVITY REQUIREMENTS

SWPPP AMENDMENTS (SECTION 6):

- 1. ONE OF THE INDIVIDUALS DESCRIBED IN ITEM 21.2.A OR ITEM 21.2.B OR ANOTHER QUALIFIED INDIVIDUAL MUST COMPLETE ALL SWPPP CHANGES. CHANGES INVOLVING THE USE OF A LESS STRINGENT BMP MUST INCLUDE A JUSTIFICATION DESCRIBING HOW THE REPLACEMENT BMP IS EFFECTIVE FOR THE SITE CHARACTERISTICS.
- 2. PERMITTEES MUST AMEND THE SWPPP TO INCLUDE ADDITIONAL OR MODIFIED BMPS AS NECESSARY TO CORRECT PROBLEMS IDENTIFIED OR ADDRESS SITUATIONS WHENEVER THERE IS A CHANGE IN DESIGN, CONSTRUCTION. OPERATION. MAINTENANCE. WEATHER OR SEASONAL CONDITIONS HAVING A SIGNIFICANT EFFECT ON THE DISCHARGE OF POLLUTANTS TO SURFACE WATERS OR GROUNDWATER.
- 3. PERMITTEES MUST AMEND THE SWPPP TO INCLUDE ADDITIONAL OR MODIFIED BMPS AS NECESSARY TO CORRECT PROBLEMS IDENTIFIED OR ADDRESS SITUATIONS WHENEVER INSPECTIONS OR INVESTIGATIONS BY THE SITE OWNER OR OPERATOR. USEPA OR MPCA OFFICIALS INDICATE THE SWPPP IS NOT EFFECTIVE IN ELIMINATING OR SIGNIFICANTLY MINIMIZING THE DISCHARGE OF POLLUTANTS TO SURFACE WATERS OR GROUNDWATER OR THE DISCHARGES ARE CAUSING WATER QUALITY STANDARD EXCEEDANCES (E.G., NUISANCE CONDITIONS AS DEFINED IN MINN. R. 7050.0210, SUBP. 2) OR THE SWPPP IS NOT CONSISTENT WITH THE OBJECTIVES OF A USEPA APPROVED TMDL.

BMP SELECTION AND INSTALLATION (SECTION 7):

1. PERMITTEES MUST SELECT, INSTALL, AND MAINTAIN THE BMPS IDENTIFIED IN THE SWPPP AND IN THIS PERMIT IN AN APPROPRIATE AND FUNCTIONAL MANNER AND IN ACCORDANCE WITH RELEVANT MANUFACTURER SPECIFICATIONS AND ACCEPTED ENGINEERING PRACTICES.

EROSION PREVENTION (SECTION 8):

RESTRICTION PERIOD

1. BEFORE WORK BEGINS, PERMITTEES MUST DELINEATE THE LOCATION OF AREAS NOT TO BE DISTURBED. 2. PERMITTEES MUST MINIMIZE THE NEED FOR DISTURBANCE OF PORTIONS OF THE PROJECT WITH STEEP SLOPES, WHEN STEEP SLOPES MUST BE DISTURBED, PERMITTEES MUST USE TECHNIQUES SUCH AS PHASING AND STABILIZATION

PRACTICES DESIGNED FOR STEEP SLOPES (E.G., SLOPE DRAINING AND TERRACING).

- 3. PERMITTEES MUST STABILIZE ALL EXPOSED SOIL AREAS, INCLUDING STOCKPILES. STABILIZATION MUST BE INITIATED IMMEDIATELY TO LIMIT SOIL EROSION WHEN CONSTRUCTION ACTIVITY HAS PERMANENTLY OR TEMPORARILY CEASED ON ANY PORTION OF THE SITE AND WILL NOT RESUME FOR A PERIOD EXCEEDING 14 CALENDAR DAYS, STABILIZATION MUST BE COMPLETED NO LATER THAN 14 CALENDAR DAYS AFTER THE CONSTRUCTION ACTIVITY HAS CEASED. STABILIZATION IS NOT REQUIRED ON CONSTRUCTED BASE COMPONENTS OF ROADS, PARKING LOTS AND SIMILAR SURFACES. STABILIZATION IS NOT REQUIRED ON TEMPORARY STOCKPILES WITHOUT SIGNIFICANT SILT, CLAY OR ORGANIC COMPONENTS (E.G., CLEAN AGGREGATE STOCKPILES, DEMOLITION CONCRETE STOCKPILES, SAND STOCKPILES) BUT
- PERMITTEES MUST PROVIDE SEDIMENT CONTROLS AT THE BASE OF THE STOCKPILE. 4. FOR PUBLIC WATERS THAT THE MINNESOTA DNR HAS PROMULGATED "WORK IN WATER RESTRICTIONS" DURING SPECIFIED FISH SPAWNING TIME FRAMES, PERMITTEES MUST COMPLETE STABILIZATION OF ALL EXPOSED SOIL AREAS WITHIN 200 FEET OF THE WATER'S EDGE, AND THAT DRAIN TO THESE WATERS, WITHIN 24 HOURS DURING THE
- 5. PERMITTEES MUST STABILIZE THE NORMAL WETTED PERIMETER OF THE LAST 200 LINEAR FEET OF TEMPORARY OR PERMANENT DRAINAGE DITCHES OR SWALES THAT DRAIN WATER FROM THE SITE WITHIN 24 HOURS AFTER CONNECTING TO A SURFACE WATER OR PROPERTY EDGE. PERMITTEES MUST COMPLETE STABILIZATION OF REMAINING PORTIONS OF TEMPORARY OR PERMANENT DITCHES OR SWALES WITHIN 14 CALENDAR DAYS AFTER CONNECTING TO A SURFACE WATER OR PROPERTY EDGE AND CONSTRUCTION IN THAT PORTION OF THE DITCH TEMPORARILY OR PERMANENTLY
- CEASES 6. TEMPORARY OR PERMANENT DITCHES OR SWALES BEING USED AS A SEDIMENT CONTAINMENT SYSTEM DURING CONSTRUCTION (WITH PROPERLY DESIGNED ROCK-DITCH CHECKS, BIO ROLLS, SILT DIKES, ETC.) DO NOT NEED TO BE STABILIZED. PERMITTEES MUST STABILIZE THESE AREAS WITHIN 24 HOURS AFTER THEIR USE AS A SEDIMENT
- CONTAINMENT SYSTEM CEASES 7. PERMITTEES MUST NOT USE MULCH, HYDROMULCH, TACKIFIER, POLYACRYLAMIDE OR SIMILAR EROSION PREVENTION PRACTICES WITHIN ANY PORTION OF THE NORMAL WETTED PERIMETER OF A TEMPORARY OR PERMANENT DRAINAGE
- DITCH OR SWALE SECTION WITH A CONTINUOUS SLOPE OF GREATER THAN 2 PERCENT. 8. PERMITTEES MUST PROVIDE TEMPORARY OR PERMANENT ENERGY DISSIPATION AT ALL PIPE OUTLETS WITHIN 24 HOURS

AFTER CONNECTION TO A SURFACE WATER OR PERMANENT STORMWATER TREATMENT SYSTEM. 9. PERMITTEES MUST NOT DISTURB MORE LAND (I.E., PHASING) THAN CAN BE EFFECTIVELY INSPECTED AND MAINTAINED IN POLLUTION PREVENTION MANAGEMENT (SECTION 12): ACCORDANCE WITH SECTION 11.

SEDIMENT CONTROL (SECTION 9):

- 1. PERMITTEES MUST ESTABLISH SEDIMENT CONTROL BMPS ON ALL DOWNGRADIENT PERIMETERS OF THE SITE AND DOWNGRADIENT AREAS OF THE SITE THAT DRAIN TO ANY SURFACE WATER, INCLUDING CURB AND GUTTER SYSTEMS. PERMITTEES MUST LOCATE SEDIMENT CONTROL PRACTICES UPGRADIENT OF ANY BUFFER ZONES. PERMITTEES MUST INSTALL SEDIMENT CONTROL PRACTICES BEFORE ANY UPGRADIENT LAND-DISTURBING ACTIVITIES BEGIN AND MUST KEEP THE SEDIMENT CONTROL PRACTICES IN PLACE UNTIL THEY ESTABLISH PERMANENT COVER.
- 2. IF DOWNGRADIENT SEDIMENT CONTROLS ARE OVERLOADED, BASED ON FREQUENT FAILURE OR EXCESSIVE MAINTENANCE REQUIREMENTS, PERMITTEES MUST INSTALL ADDITIONAL UPGRADIENT SEDIMENT CONTROL PRACTICES OR REDUNDANT BMPS TO ELIMINATE THE OVERLOADING AND AMEND THE SWPPP TO IDENTIFY THESE ADDITIONAL
- 3. TEMPORARY OR PERMANENT DRAINAGE DITCHES AND SEDIMENT BASINS DESIGNED AS PART OF A SEDIMENT CONTAINMENT SYSTEM (E.G., DITCHES WITH ROCK-CHECK DAMS) REQUIRE SEDIMENT CONTROL PRACTICES ONLY AS
- APPROPRIATE FOR SITE CONDITIONS 4. A FLOATING SILT CURTAIN PLACED IN THE WATER IS NOT A SEDIMENT CONTROL BMP TO SATISFY ITEM 9.2 EXCEPT WHEN WORKING ON A SHORELINE OR BELOW THE WATERLINE. IMMEDIATELY AFTER THE SHORT TERM CONSTRUCTION ACTIVITY
- (E.G., INSTALLATION OF RIP RAP ALONG THE SHORELINE) IN THAT AREA IS COMPLETE, PERMITTEES MUST INSTALL AN UPLAND PERIMETER CONTROL PRACTICE IF EXPOSED SOILS STILL DRAIN TO A SURFACE WATER. 5. PERMITTEES MUST RE-INSTALL ALL SEDIMENT CONTROL PRACTICES ADJUSTED OR REMOVED TO ACCOMMODATE SHORT-TERM ACTIVITIES SUCH AS CLEARING OR GRUBBING, OR PASSAGE OF VEHICLES, IMMEDIATELY AFTER THE
- SHORT-TERM ACTIVITY IS COMPLETED. PERMITTEES MUST RE-INSTALL SEDIMENT CONTROL PRACTICES BEFORE THE NEXT PRECIPITATION EVENT EVEN IF THE SHORT-TERM ACTIVITY IS NOT COMPLETE. 6. PERMITTEES MUST PROTECT ALL STORM DRAIN INLETS USING APPROPRIATE BMPS DURING CONSTRUCTION UNTIL THEY
- ESTABLISH PERMANENT COVER ON ALL AREAS WITH POTENTIAL FOR DISCHARGING TO THE INLET. 7. PERMITTEES MAY REMOVE INLET PROTECTION FOR A PARTICULAR INLET IF A SPECIFIC SAFETY CONCERN (E.G. STREET FLOODING/FREEZING) IS IDENTIFIED BY THE PERMITTEES OR THE JURISDICTIONAL AUTHORITY (E.G.,
- CITY/COUNTY/TOWNSHIP/MINNESOTA DEPARTMENT OF TRANSPORTATION ENGINEER). PERMITTEES MUST DOCUMENT THE NEED FOR REMOVAL IN THE SWPPP 8. PERMITTEES MUST PROVIDE SILT FENCE OR OTHER EFFECTIVE SEDIMENT CONTROLS AT THE BASE OF STOCKPILES ON
- THE DOWNGRADIENT PERIMETER 9. PERMITTEES MUST LOCATE STOCKPILES OUTSIDE OF NATURAL BUFFERS OR SURFACE WATERS, INCLUDING STORMWATER CONVEYANCES SUCH AS CURB AND GUTTER SYSTEMS UNLESS THERE IS A BYPASS IN PLACE FOR THE
- 10. PERMITTEES MUST INSTALL A VEHICLE TRACKING BMP TO MINIMIZE THE TRACK OUT OF SEDIMENT FROM THE
- CONSTRUCTION SITE OR ONTO PAVED ROADS WITHIN THE SITE. 11. PERMITTEES MUST USE STREET SWEEPING IF VEHICLE TRACKING BMPS ARE NOT ADEQUATE TO PREVENT SEDIMENT
- TRACKING ONTO THE STREET 12. PERMITTEES MUST INSTALL TEMPORARY SEDIMENT BASINS AS REQUIRED IN SECTION 14.
- 13. IN ANY AREAS OF THE SITE WHERE FINAL VEGETATIVE STABILIZATION WILL OCCUR, PERMITTEES MUST RESTRICT VEHICLE AND EQUIPMENT USE TO MINIMIZE SOIL COMPACTION.
- 14. PERMITTEES MUST PRESERVE TOPSOIL ON THE SITE, UNLESS INFEASIBLE. 15. PERMITTEES MUST DIRECT DISCHARGES FROM BMPS TO VEGETATED AREAS UNLESS INFEASIBLE 16, PERMITTEES MUST PRESERVE A 50 FOOT NATURAL BUFFER OR, IF A BUFFER IS INFEASIBLE ON THE SITE, PROVIDE
- REDUNDANT (DOUBLE) PERIMETER SEDIMENT CONTROLS WHEN A SURFACE WATER IS LOCATED WITHIN 50 FEET OF THE PROJECT'S EARTH DISTURBANCES AND STORMWATER FLOWS TO THE SURFACE WATER. PERMITTEES MUST INSTALL PERIMETER SEDIMENT CONTROLS AT LEAST 5 FEET APART UNLESS LIMITED BY LACK OF AVAILABLE SPACE. NATURAL BUFFERS ARE NOT REQUIRED ADJACENT TO ROAD DITCHES. JUDICIAL DITCHES. COUNTY DITCHES. STORMWATER CONVEYANCE CHANNELS, STORM DRAIN INLETS, AND SEDIMENT BASINS. IF PRESERVING THE BUFFER IS INFEASIBLE
- INSTALLED IN A MANNER THAT RETAINS ALL STORMWATER. 17. PERMITTEES MUST USE POLYMERS, FLOCCULANTS, OR OTHER SEDIMENTATION TREATMENT CHEMICALS IN ACCORDANCE WITH ACCEPTED ENGINEERING PRACTICES, DOSING SPECIFICATIONS AND SEDIMENT REMOVAL DESIGN SPECIFICATIONS PROVIDED BY THE MANUFACTURER OR SUPPLIER. THE PERMITTEES MUST USE CONVENTIONAL EROSION AND SEDIMENT CONTROLS PRIOR TO CHEMICAL ADDITION AND MUST DIRECT TREATED STORMWATER TO A SEDIMENT CONTROL SYSTEM FOR FILTRATION OR SETTLEMENT OF THE FLOC PRIOR TO DISCHARGE.

PERMITTEES MUST DOCUMENT THE REASONS IN THE SWPPP. SHEET PILING IS A REDUNDANT PERIMETER CONTROL IF

DEWATERING AND BASIN DRAINING (SECTION 10):

- 1. PERMITTEES MUST DISCHARGE TURBID OR SEDIMENT-LADEN WATERS RELATED TO DEWATERING OR BASIN DRAINING (E.G., PUMPED DISCHARGES, TRENCH/DITCH CUTS FOR DRAINAGE) TO A TEMPORARY OR PERMANENT SEDIMENT BASIN ON THE PROJECT SITE UNLESS INFEASIBLE. PERMITTEES MAY DEWATER TO SURFACE WATERS IF THEY VISUALLY CHECK TO ENSURE ADEQUATE TREATMENT HAS BEEN OBTAINED AND NUISANCE CONDITIONS (SEE MINN. R. 7050.0210, SUBP. 2) WILL NOT RESULT FROM THE DISCHARGE, IF PERMITTEES CANNOT DISCHARGE THE WATER TO A SEDIMENTATION BASIN PRIOR TO ENTERING A SURFACE WATER. PERMITTEES MUST TREAT IT WITH APPROPRIATE BMPS SUCH THAT THE
- DISCHARGE DOES NOT ADVERSELY AFFECT THE SURFACE WATER OR DOWNSTREAM PROPERTIES. 2. IF PERMITTEES MUST DISCHARGE WATER CONTAINING OIL OR GREASE, THEY MUST USE AN OIL-WATER SEPARATOR OR SUITABLE FILTRATION DEVICE (E.G., CARTRIDGE FILTERS, ABSORBENTS PADS) PRIOR TO DISCHARGE
- 3. PERMITTEES MUST DISCHARGE ALL WATER FROM DEWATERING OR BASIN-DRAINING ACTIVITIES IN A MANNER THAT DOES NOT CAUSE EROSION OR SCOUR IN THE IMMEDIATE VICINITY OF DISCHARGE POINTS OR INUNDATION OF WETLANDS IN THE IMMEDIATE VICINITY OF DISCHARGE POINTS THAT CAUSES SIGNIFICANT ADVERSE IMPACT TO THE WETLAND.
- 4. IF PERMITTEES USE FILTERS WITH BACKWASH WATER, THEY MUST HAUL THE BACKWASH WATER AWAY FOR DISPOSA RETURN THE BACKWASH WATER TO THE BEGINNING OF THE TREATMENT PROCESS, OR INCORPORATE THE BACKWASH WATER INTO THE SITE IN A MANNER THAT DOES NOT CAUSE EROSION.

INSPECTIONS AND MAINTENANCE (SECTION 11):

- 1. PERMITTEES MUST ENSURE A TRAINED PERSON, AS IDENTIFIED IN ITEM 21.2.B, WILL INSPECT THE ENTIRE CONSTRUCTION SITE AT LEAST ONCE EVERY SEVEN (7) DAYS DURING ACTIVE CONSTRUCTION AND WITHIN 24 HOURS AFTER A RAINFALL EVENT GREATER THAN 1/2 INCH IN 24 HOURS.
- 2. PERMITTEES MUST INSPECT AND MAINTAIN ALL PERMANENT STORMWATER TREATMENT BMPS. 3. PERMITTEES MUST INSPECT ALL EROSION PREVENTION AND SEDIMENT CONTROL BMPS AND POLLUTION PREVENTION MANAGEMENT MEASURES TO ENSURE INTEGRITY AND EFFECTIVENESS, PERMITTEES MUST REPAIR, REPLACE OR SUPPLEMENT ALL NONFUNCTIONAL BMPS WITH FUNCTIONAL BMPS BY THE END OF THE NEXT BUSINESS DAY AFTER
- DISCOVERY UNLESS ANOTHER TIME FRAME IS SPECIFIED IN ITEM 11.5 OR 11.6. PERMITTEES MAY TAKE ADDITIONAL TIME IF SLOPES FIELD CONDITIONS PREVENT ACCESS TO THE AREA. 4. DURING EACH INSPECTION, PERMITTEES MUST INSPECT SURFACE WATERS, INCLUDING DRAINAGE DITCHES AND CONVEYANCE SYSTEMS BUT NOT CURB AND GUTTER SYSTEMS, FOR EVIDENCE OF EROSION AND SEDIMENT DEPOSITION. • SEE PLAN FOR MORE DETAILED DITCH AND STEEP SLOPE EROSION CONTROL TREATMENTS. PERMITTEES MUST REMOVE ALL DELTAS AND SEDIMENT DEPOSITED IN SURFACE WATERS, INCLUDING DRAINAGE WAYS, CATCH BASINS. AND OTHER DRAINAGE SYSTEMS AND RESTABILIZE THE AREAS WHERE SEDIMENT REMOVAL RESULTS IN
- EXPOSED SOIL. PERMITTEES MUST COMPLETE REMOVAL AND STABILIZATION WITHIN SEVEN (7) CALENDAR DAYS OF DISCOVERY UNLESS PRECLUDED BY LEGAL, REGULATORY, OR PHYSICAL ACCESS CONSTRAINTS. PERMITTEES MUST USE ALL REASONABLE EFFORTS TO OBTAIN ACCESS. IF PRECLUDED, REMOVAL AND STABILIZATION MUST TAKE PLACE WITHIN SEVEN (7) DAYS OF OBTAINING ACCESS, PERMITTEES ARE RESPONSIBLE FOR CONTACTING ALL LOCAL, REGIONAL, STATE AND FEDERAL AUTHORITIES AND RECEIVING ANY APPLICABLE PERMITS, PRIOR TO CONDUCTING ANY WORK IN SURFACE
- WATERS. 5. PERMITTEES MUST INSPECT CONSTRUCTION SITE VEHICLE EXIT LOCATIONS, STREETS AND CURB AND GUTTER SYSTEMS WITHIN AND ADJACENT TO THE PROJECT FOR SEDIMENTATION FROM EROSION OR TRACKED SEDIMENT FROM VEHICLES. PERMITTEES MUST REMOVE SEDIMENT FROM ALL PAVED SURFACES WITHIN ONE (1) CALENDAR DAY OF DISCOVERY OR. IF
- APPLICABLE, WITHIN A SHORTER TIME TO AVOID A SAFETY HAZARD TO USERS OF PUBLIC STREETS. 6. PERMITTEES MUST REPAIR, REPLACE OR SUPPLEMENT ALL PERIMETER CONTROL DEVICES WHEN THEY BECOME NONFUNCTIONAL OR THE SEDIMENT REACHES 1/2 OF THE HEIGHT OF THE DEVICE.
- DEPTH OF SEDIMENT COLLECTED IN THE BASIN REACHES 1/2 THE STORAGE VOLUME. 8. PERMITTEES MUST ENSURE THAT AT LEAST ONE INDIVIDUAL PRESENT ON THE SITE (OR AVAILABLE TO THE PROJECT SITE IN THREE (3) CALENDAR DAYS) IS TRAINED IN THE JOB DUTIES DESCRIBED IN ITEM 21.2.B. 9. PERMITTEES MAY ADJUST THE INSPECTION SCHEDULE DESCRIBED IN ITEM 11.2 AS FOLLOWS

a. INSPECTIONS OF AREAS WITH PERMANENT COVER CAN BE REDUCED TO ONCE PER MONTH, EVEN IF CONSTRUCTION

7. PERMITTEES MUST DRAIN TEMPORARY AND PERMANENT SEDIMENTATION BASINS AND REMOVE THE SEDIMENT WHEN THE

- ACTIVITY CONTINUES ON OTHER PORTIONS OF THE SITE; OR b. WHERE SITES HAVE PERMANENT COVER ON ALL EXPOSED SOIL AND NO CONSTRUCTION ACTIVITY IS OCCURRING ANYWHERE ON THE SITE, INSPECTIONS CAN BE REDUCED TO ONCE PER MONTH AND, AFTER 12 MONTHS, MAY BE SUSPENDED COMPLETELY UNTIL CONSTRUCTION ACTIVITY RESUMES. THE MPCA MAY REQUIRE INSPECTIONS TO
- RESUME IF CONDITIONS WARRANT; OR c. WHERE CONSTRUCTION ACTIVITY HAS BEEN SUSPENDED DUE TO FROZEN GROUND CONDITIONS, INSPECTIONS MAY BE SUSPENDED. INSPECTIONS MUST RESUME WITHIN 24 HOURS OF RUNOFF OCCURRING, OR UPON RESUMING CONSTRUCTION, WHICHEVER COMES FIRST.
- 10. PERMITTEES MUST RECORD ALL INSPECTIONS AND MAINTENANCE ACTIVITIES WITHIN 24 HOURS OF BEING CONDUCTED AND THESE RECORDS MUST BE RETAINED WITH THE SWPPP. THESE RECORDS MUST INCLUDE:
- a. DATE AND TIME OF INSPECTIONS; AND b. NAME OF PERSONS CONDUCTING INSPECTIONS; AND
- c. ACCURATE FINDINGS OF INSPECTIONS, INCLUDING THE SPECIFIC LOCATION WHERE CORRECTIVE ACTIONS ARE NEEDED; AND
- d. CORRECTIVE ACTIONS TAKEN (INCLUDING DATES, TIMES, AND PARTY COMPLETING MAINTENANCE ACTIVITIES); AND e. DATE OF ALL RAINFALL EVENTS GREATER THAN 1/2 INCHES IN 24 HOURS, AND THE AMOUNT OF RAINFALL FOR EACH EVENT. PERMITTEES MUST OBTAIN RAINFALL AMOUNTS BY EITHER A PROPERLY MAINTAINED RAIN GAUGE INSTALLED ONSITE, A WEATHER STATION THAT IS WITHIN ONE (1) MILE OF YOUR LOCATION, OR A WEATHER REPORTING SYSTEM THAT PROVIDES SITE SPECIFIC RAINFALL DATA FROM RADAR SUMMARIES; AND
- f. IF PERMITTEES OBSERVE A DISCHARGE DURING THE INSPECTION, THEY MUST RECORD AND SHOULD PHOTOGRAPH AND DESCRIBE THE LOCATION OF THE DISCHARGE (I.E., COLOR, ODOR, SETTLED OR SUSPENDED SOLIDS, OIL SHEEN, AND OTHER OBVIOUS INDICATORS OF POLLUTANTS); AND
- g. ANY AMENDMENTS TO THE SWPPP PROPOSED AS A RESULT OF THE INSPECTION MUST BE DOCUMENTED AS REQUIRED IN SECTION 6 WITHIN SEVEN (7) CALENDAR DAYS.

- 1. PERMITTEES MUST PLACE BUILDING PRODUCTS AND LANDSCAPE MATERIALS UNDER COVER (E.G., PLASTIC SHEETING OR TEMPORARY ROOFS) OR PROTECT THEM BY SIMILARLY EFFECTIVE MEANS DESIGNED TO MINIMIZE CONTACT WITH STORMWATER. PERMITTEES ARE NOT REQUIRED TO COVER OR PROTECT PRODUCTS WHICH ARE EITHER NOT A SOURCE OF CONTAMINATION TO STORMWATER OR ARE DESIGNED TO BE EXPOSED TO STORMWATER.
- 2. PERMITTEES MUST PLACE PESTICIDES, FERTILIZERS AND TREATMENT CHEMICALS UNDER COVER (E.G., PLASTIC SHEETING OR TEMPORARY ROOFS) OR PROTECT THEM BY SIMILARLY EFFECTIVE MEANS DESIGNED TO MINIMIZE CONTACT WITH STORMWATER.
- 3. PERMITTEES MUST STORE HAZARDOUS MATERIALS AND TOXIC WASTE, (INCLUDING OIL, DIESEL FUEL, GASOLINE, HYDRAULIC FLUIDS, PAINT SOLVENTS, PETROLEUM-BASED PRODUCTS, WOOD PRESERVATIVES, ADDITIVES, CURING COMPOUNDS, AND ACIDS) IN SEALED CONTAINERS TO PREVENT SPILLS, LEAKS OR OTHER DISCHARGE. STORAGE AND DISPOSAL OF HAZARDOUS WASTE MATERIALS MUST BE IN COMPLIANCE WITH MINN, R, CH, 7045 INCLUDING SECONDARY CONTAINMENT AS APPLICABLE
- 4. PERMITTEES MUST PROPERLY STORE, COLLECT AND DISPOSE SOLID WASTE IN COMPLIANCE WITH MINN. R. CH. 7035. 5. PERMITTEES MUST POSITION PORTABLE TOILETS SO THEY ARE SECURE AND WILL NOT TIP OR BE KNOCKED OVER. PERMITTEES MUST PROPERLY DISPOSE SANITARY WASTE IN ACCORDANCE WITH MINN. R. CH. 7041. 6. PERMITTEES MUST TAKE REASONABLE STEPS TO PREVENT THE DISCHARGE OF SPILLED OR LEAKED CHEMICALS,
- INCLUDING FUEL, FROM ANY AREA WHERE CHEMICALS OR FUEL WILL BE LOADED OR UNLOADED INCLUDING THE USE OF DRIP PANS OR ABSORBENTS UNLESS INFEASIBLE. PERMITTEES MUST ENSURE ADEQUATE SUPPLIES ARE AVAILABLE AT ALL TIMES TO CLEAN UP DISCHARGED MATERIALS AND THAT AN APPROPRIATE DISPOSAL METHOD IS AVAILABLE FOR RECOVERED SPILLED MATERIALS. PERMITTEES MUST REPORT AND CLEAN UP SPILLS IMMEDIATELY AS REQUIRED BY MINN. STAT. 115.061, USING DRY CLEAN UP MEASURES WHERE POSSIBLE.
- 7. PERMITTEES MUST LIMIT VEHICLE EXTERIOR WASHING AND EQUIPMENT TO A DEFINED AREA OF THE SITE. PERMITTEES MUST CONTAIN RUNOFF FROM THE WASHING AREA IN A SEDIMENT BASIN OR OTHER SIMILARLY EFFECTIVE CONTROLS AND MUST DISPOSE WASTE FROM THE WASHING ACTIVITY PROPERLY. PERMITTEES MUST PROPERLY USE AND STORE SOAPS, DETERGENTS, OR SOLVENTS.
- 8. PERMITTEES MUST PROVIDE EFFECTIVE CONTAINMENT FOR ALL LIQUID AND SOLID WASTES GENERATED BY WASHOUT OPERATIONS (E.G., CONCRETE, STUCCO, PAINT, FORM RELEASE OILS, CURING COMPOUNDS AND OTHER CONSTRUCTION MATERIALS) RELATED TO THE CONSTRUCTION ACTIVITY. PERMITTEES MUST PREVENT LIQUID AND SOLID WASHOUT WASTES FROM CONTACTING THE GROUND AND MUST DESIGN THE CONTAINMENT SO IT DOES NOT RESULT IN RUNOFF FROM THE WASHOUT OPERATIONS OR AREAS, PERMITTEES MUST PROPERLY DISPOSE LIQUID AND SOLID WASTES IN COMPLIANCE WITH MPCA RULES. PERMITTEES MUST INSTALL A SIGN INDICATING THE LOCATION OF THE WASHOUT

PERMIT TERMINATION (SECTION 4 AND SECTION 13):

- 1. PERMITTEES MUST SUBMIT A NOT WITHIN 30 DAYS AFTER ALL TERMINATION CONDITIONS LISTED IN SECTION 13 ARE
- 2. PERMITTEES MUST SUBMIT A NOT WITHIN 30 DAYS AFTER SELLING OR OTHERWISE LEGALLY TRANSFERRING THE ENTIRE SITE, INCLUDING PERMIT RESPONSIBILITY FOR ROADS (E.G., STREET SWEEPING) AND STORMWATER INFRASTRUCTURE FINAL CLEAN OUT, OR TRANSFERRING PORTIONS OF A SITE TO ANOTHER PARTY. THE PERMITTEES' COVERAGE UNDER THIS PERMIT TERMINATES AT MIDNIGHT ON THE SUBMISSION DATE OF THE NOT.
- 3. PERMITTEES MUST COMPLETE ALL CONSTRUCTION ACTIVITY AND MUST INSTALL PERMANENT COVER OVER ALL AREAS PRIOR TO SUBMITTING THE NOT. VEGETATIVE COVER MUST CONSIST OF A UNIFORM PERENNIAL VEGETATION WITH A DENSITY OF 70 PERCENT OF ITS EXPECTED FINAL GROWTH. VEGETATION IS NOT REQUIRED WHERE THE FUNCTION OF A SPECIFIC AREA DICTATES NO VEGETATION, SUCH AS IMPERVIOUS SURFACES OR THE BASE OF A SAND FILTER. 4. PERMITTEES MUST CLEAN THE PERMANENT STORMWATER TREATMENT SYSTEM OF ANY ACCUMULATED SEDIMENT AND MUST ENSURE THE SYSTEM MEETS ALL APPLICABLE REQUIREMENTS IN SECTION 15 THROUGH 19 AND IS OPERATING AS
- 5. PERMITTEES MUST REMOVE ALL SEDIMENT FROM CONVEYANCE SYSTEMS PRIOR TO SUBMITTING THE NOT. 6. PERMITTEES MUST REMOVE ALL TEMPORARY SYNTHETIC EROSION PREVENTION AND SEDIMENT CONTROL BMPS PRIOR
- TO SUBMITTING THE NOT. PERMITTEES MAY LEAVE BMPS DESIGNED TO DECOMPOSE ON-SITE IN PLACE. 7. FOR RESIDENTIAL CONSTRUCTION ONLY, PERMIT COVERAGE TERMINATES ON INDIVIDUAL LOTS IF THE STRUCTURES ARE FINISHED AND TEMPORARY EROSION PREVENTION AND DOWNGRADIENT PERIMETER CONTROL IS COMPLETE, THE RESIDENCE SELLS TO THE HOMEOWNER, AND THE PERMITTEE DISTRIBUTES THE MPCA'S "HOMEOWNER FACT SHEET" TO THE HOMEOWNER.
- 8. FOR CONSTRUCTION PROJECTS ON AGRICULTURAL LAND (E.G., PIPELINES ACROSS CROPLAND), PERMITTEES MUST RETURN THE DISTURBED LAND TO ITS PRECONSTRUCTION AGRICULTURAL USE PRIOR TO SUBMITTING THE NOT.

SEED NOTES:

ALL SEED MIXES AND APPLICATION SHALL BE IN ACCORDANCE WITH THE MNDOT SEEDING MANUAL.

THE CONTRACTOR IS RESPONSIBLE TO SALVAGE AND PRESERVE EXISTING TOPSOIL NECESSARY FOR FINAL STABILIZATION AND TO ALSO MINIMIZE COMPACTION IN ALL LANDSCAPE AREAS. IMMEDIATELY BEFORE SEEDING THE SOIL SHALL BE TILLED TO A MINIMUM DEPTH OF 3 INCHES.

TEMPORARY EROSION CONTROL SEEDING, MULCHING & BLANKET

TEMPORARY SEED SHALL BE MNDOT SEED MIX 21-112 (WINTER WHEAT COVER CROP) FOR WINTER AND 21-111 (OATS) COVER CROP) FOR SPRING/SUMMER APPLICATIONS. BOTH SEED MIXES SHALL BE APPLIED AT A SEEDING RATE OF 100

IMMEDIATELY AFTER SEEDING, WITHIN 24 HOURS, MNDOT TYPE 1 MULCH SHOULD BE APPLIED TO PROTECT AND ENHANCE

- SEED GERMINATION. MULCH SHALL BE APPLIED AT 90% COVERAGE (2 TONS PER ACRE OF STRAW MULCH)
- 3:1 (HORIZ/VERT.) OR FLATTER MUCH SHALL BE COVERED WITH MULCH SLOPES STEEPER THAN 3:1 OR DITCH BOTTOMS SHALL BE COVERED WITH EROSION CONTROL BLANKET.

TRAINING SECTION 21

OWNER INFORMATION

DESIGN ENGINEER: MATTHEW R. PAVEK P.E. TRAINING COURSE: DESIGN OF SWPPP TRAINING ENTITY: UNIVERSITY OF MINNESOTA INSTRUCTOR: JOHN CHAPMAN DATES OF TRAINING COURSE: 5/15/2011 - 5/16/2011 TOTAL TRAINING HOURS: 12

RE-CERTIFICATION: 2/27/2020 (8 HOURS), EXP. 5/31/2023

JWT LAKE ST. LLC 2400 BLAISDELL AVE. MINNEAPOLIS, MN 55404

AREAS AND QUANTITIES:

	EXISTIN	G	PROPOS	SED
BUILDING COVERAGE	2,265 SF	41.7%	3,319 SF	61.0%
ALL PAVEMENTS	2,660 SF	48.9%	1,653 SF	30.4%
ALL NON-PAVEMENTS	512 SF	9.4%	465 SF	8.6%
TOTAL SITE AREA	5,437 SF	100.0%	5,437 SF	100.0%

IMPERVIOUS SURFACE		
EXISTING CONDITION	4,925 SF	90.6%
PROPOSED CONDITION	4,972 SF	91.4%
DIFFERENCE (EX. VS PROP.)	47 SF	0.9%
IMPERVIOUS TOTAL	4,972 SF	91.4%
EDOCION CONTROL OLIANTITIES		

ROSION CONTROL QUANTITIES	
STURBED AREA	7,539 SF
LT FENCE/BIO-ROLL	386 LF
ROSION CONTROL BLANKET	0 SF
ILET PROTECTION DEVICES	0± EA

NOTE: QUANTITIES ARE FOR INFORMATIONAL PURPOSES ONLY. CONTRACTOR SHALL DETERMINE FOR THEMSELVES THE EXACT QUANTITIES FOR BIDDING AND CONSTRUCTION.

SWPPP CONTACT PERSON

CONTRACTOR

SWPPP INSPECTOR TRAINING: ALL SWPPP INSPECTIONS MUST BE PERFORMED BY A PERSON THAT MEETS THE TRAINING REQUIREMENTS OF THE NPDES CONSTRUCTION SITE PERMIT TRAINING CREDENTIALS SHALL BE PROVIDED BY THE CONTRACTOR AND KEPT ON SITE WITH THE SWPPP

PARTY RESPONSIBLE FOR LONG TERM OPERATION AND MAINTENANCE OF PERMANENT STORM WATER MANAGEMENT SYSTEM

PERMANENT STORMWATER MANAGEMENT IS NOT REQUIRED AS PART OF THIS PROJECT TO MEET NPDES PERMIT REQUIREMENTS. THE PROPERTY OWNER IS RESPONSIBLE FOR THE LONG TERM OPERATION AND MAINTENANCE OF THE PROPOSED STORMWATER SYSTEM.

SWPPP ATTACHMENTS (ONLY APPLICABLE IF SITE IS 1 ACRE OR GREATER):

ATTACHMENT D: STORMWATER MANAGEMENT REPORT - ON FILE AT THE OFFICE OF PROJECT ENGINEER. AVAILABLE UPON REQUEST.

- CONTRACTOR SHALL OBTAIN A COPY OF THE FOLLOWING SWPPP ATTACHMENTS WHICH ARE A PART OF THE OVERALL SWPPP PACKAGE: ATTACHMENT A. CONSTRUCTION SWPPP TEMPLATE - SITE SPECIFIC SWPPP DOCUMENT
- ATTACHMENT B. CONSTRUCTION STORMWATER INSPECTION CHECKLIST ATTACHMENT C. MAINTENANCE PLAN FOR PERMANENT STORM WATER TREATMENT SYSTEMS
- ATTACHMENT E: GEOTECHNICAL EVALUATION REPORT ON FILE AT THE OFFICE OF PROJECT ENGINEER. AVAILABLE UPON REQUEST.

SUPPLEMENTARY SITE SPECIFIC EROSION CONTROL NOTES: THESE NOTES SUPERCEDE ANY GENERAL SWPPP NOTES.

THIS PROJECT IS LESS THAN 1.0 ACRES SO AN NPDES PERMIT IS NOT REQUIRED.

PROJECT NARRATIVE:

PROJECT IS A REDEVELOPMENT OF AN EXISTING SINGLE STORY COMMERCIAL BUILDING INTO A TWO STORY RESIDENTIAL BUILDING. SITE AND LANDSCAPE IMPROVEMENTS WILL OCCUR.

NATIVE BUFFER NARRATIVE:

INFILTRATION NARRATIVE:

PRESERVING A 50' NATURAL BUFFER AROUND WATER BODIES IS NOT REQUIRED AS PART OF THIS PROJECT BECAUSE WATER BODIES ARE NOT

INFILTRATION IS NOT REQUIRED AS PART OF THE PROJECT BECAUSE PERMANENT STORM WATER MANAGEMENT IS NOT REQUIRED.

SOIL CONTAMINATION NARRATIVE: SOILS ONSITE HAVE NOT BEEN IDENTIFIED AS CONTAMINATED. AN MPCA SOILS ASSESSMENT WAS COMPLETED AND IT WAS DETERMINED THAT

THIS SITE IS APPROPRIATE FOR INFILTRATION.

SPECIAL TMDL BMP REQUIREMENTS SITE SPECIFIC (IF REQUIRED): THIS PROJECT IS NOT WITHIN ONE MILE OF A WATER BODY AND DOES NOT DIRECTLY DISCHARGES TO ANY NEAR BY WATER BODIES.

PERMANENT STABILIZATION NOTES SITE SPECIFIC:

- FOR THIS PROJECT ALL AREAS THAT ARE NOT TO BE SODDED OR LANDSCAPED SHALL RECEIVE A NATIVE PERMANENT SEED MIX. AREAS IN BUFFERS AND ADJACENT TO OR IN WET AREAS MNDOT SEED MIX 33-261 (STORMWATER SOUTH AND WEST) AT 35 LBS PER
- DRY AREAS MNDOT SEED MIX 35-221 (DRY PRAIRIE GENERAL) AT 40 LBS PER ACRE.

MAINTENANCE SHALL BE IN ACCORDANCE TO THE MNDOT SEEDING MANUAL.

4931 W. 35th Street, Suite 200 St. Louis Park, MN 55416

civilsitegroup.com

I HEREBY CERTIFY THAT THIS PLAN SPECIFICATION, OR REPORT WAS PREPARED BY ME OR UNDER MY DIRECT SUPERVISION AND THAT I AM A DULY LICENSED PROFESSIONAL ENGINEER UNDER THE LAWS OF THE STATE OF MINNESOTA.

Matthew R. Pavek DATE 11/02/20 LICENSE NO. 44263

ISSUE/SUBMITTAL SUMMARY

DATE DESCRIPTION 10/08/2020 PDR SUBMITTAL 10/20/20 PDR SUBMITTAL 11/02/20 PDR SUBMITTAL

DRAWN BY:KB. KW REVIEWED BY: MP

PROJECT NUMBER: 20267 **REVISION SUMMARY** DATE DESCRIPTION

SWPPP - NARRATIVE

Schedule														
Symbol	Label	Image	QTY	Manufacturer	Catalog Number	Description	Number Lamps	Filename	Lumens per Lamp	Lumen Multiplie r	LLF	Wattage	Efficiency	Distri io
	AA2		1	Luminis Canada Inc.	BVA21-L1L40-TYP4	Bellevue Area Amber	1	BVA21-L1L40- TYP4.ies	3775	1	0.9	67.4	100%	TYPE
	W		6	Lithonia Lighting	WPX1 LED P2 40K Mvolt	WPX1 LED wallpack 3000lm 4000K color temperature 120- 277 Volts	1	WPX1_LED_P2_ 40K_Mvolt.ies	2913	1	0.9	24.42	100%	TYPE I SHOR BUG RATIN B1 - U
Statistics Description	Symb	ol Avg Max	Min M	lax/Min Avg/Mi	n									

Statistics

Description Symbol Avg Max Min Max/Min Avg/Min Total Area @ + 0.6 fc 8.8 fc 0.0 fc N/A N/A


Note

1. Davis and Associates, Inc does not assume responsibility for the interpretation of this calculation, or compliance to local or state lighting codes and ordinances.

2. All readings/calculations are shown @ grade.

3. Fixture heights are shown on plan.



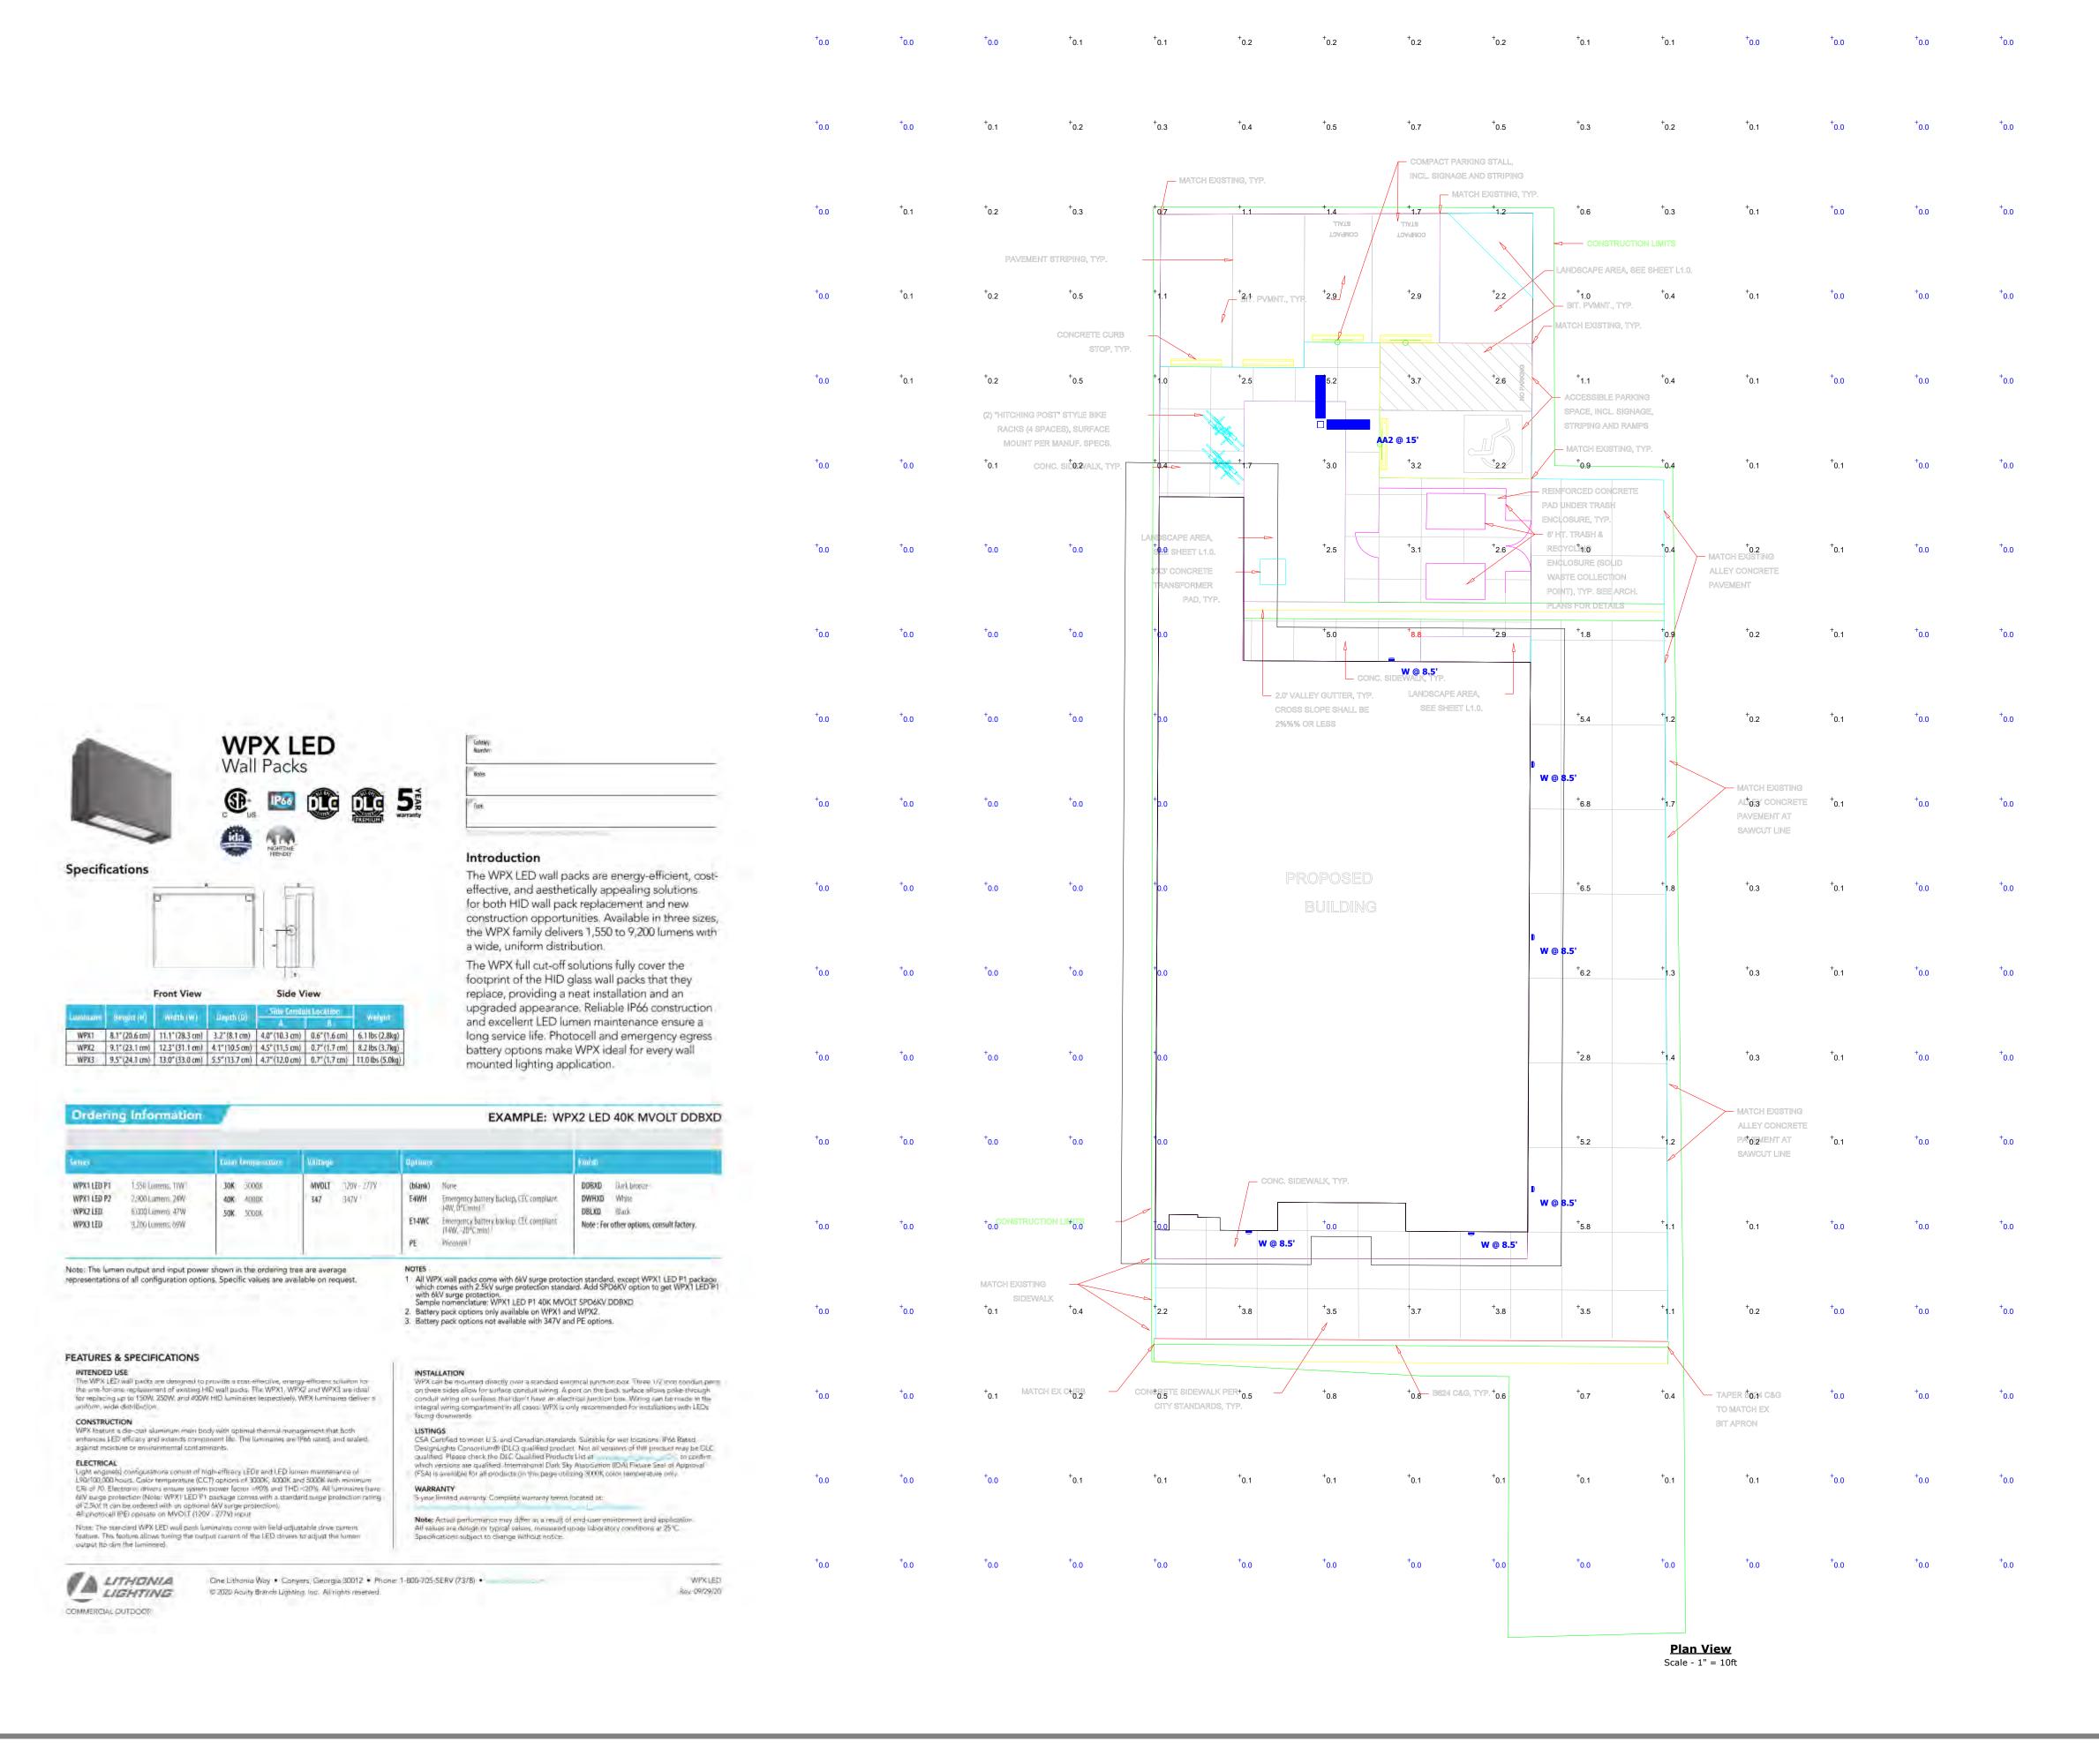

117


Designer Date


10/26/2020

Scale
Not to Scale

Drawing No.
Summary

1 of 1

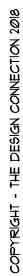

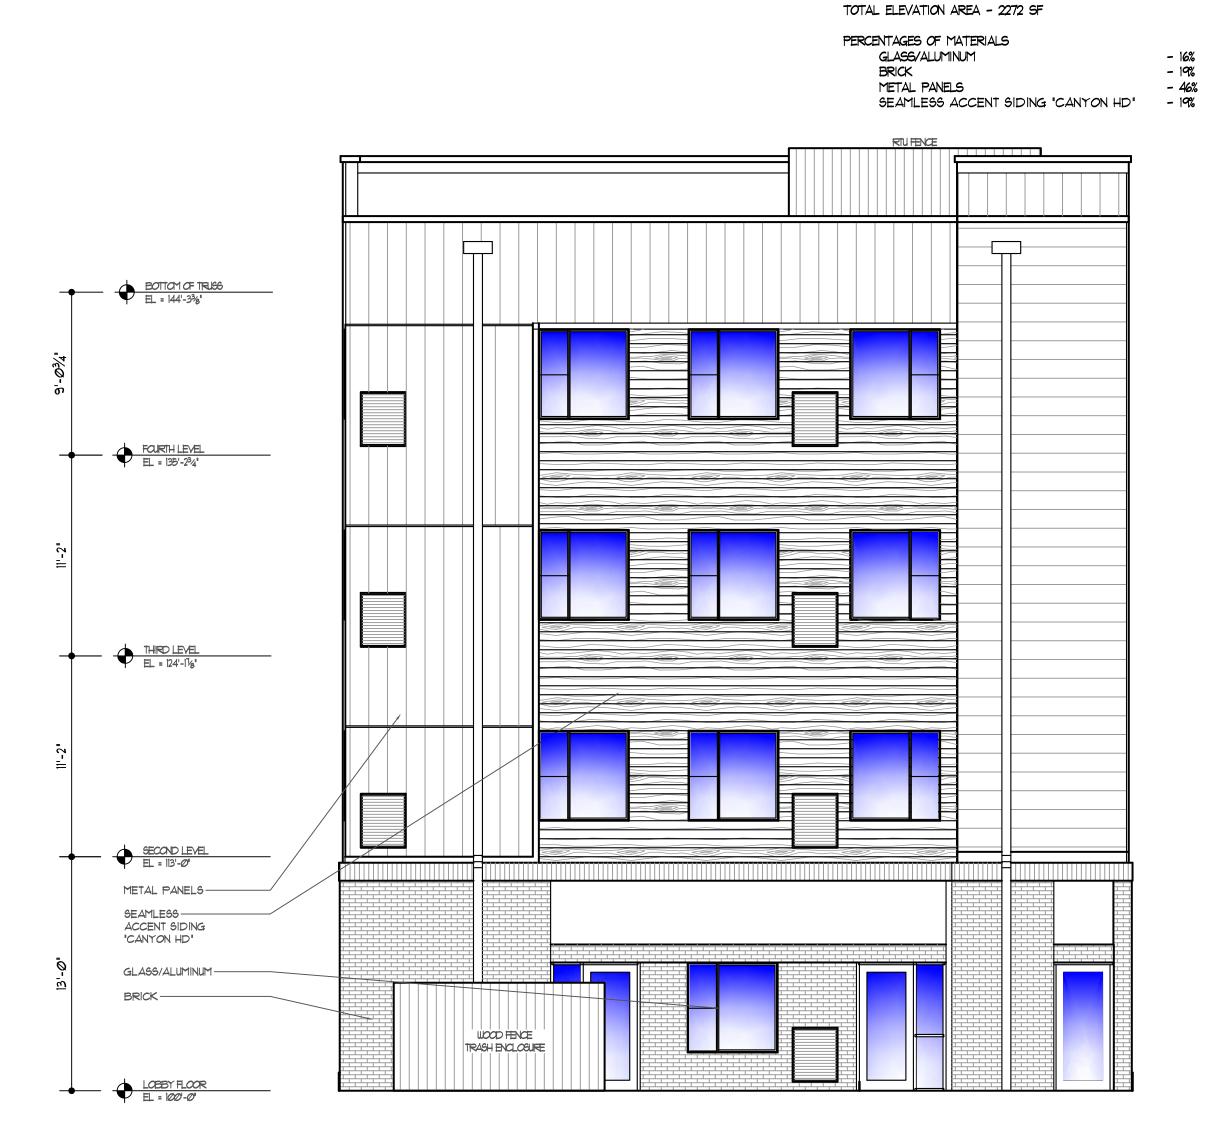

TOTAL ELEVATION AREA - 2272 SF

PERCENTAGES OF MATERIALS

GLASS/ALUMINUM BRICK METAL PANELS

SEAMLESS ACCENT SIDING "CANYON HD" - 27%

- 22% - 11% - 40%

DRAWN BY:

ARCHITECTS

Bright Pixel

Design


1647 16th Ave. NW
Rochester MN 55901
PHONE (507) 286-7869
aaron@thedesignconnection.net
www.thedesignconnection.net

AKE ST


20258 CDB / IJN PROJECT #: DRAWN BY: CHECKED BY: MJB / CDB FINAL DATE:

Oct 20, 2020 PRINTED:

NORTH & SOUTH ELEVATIONS

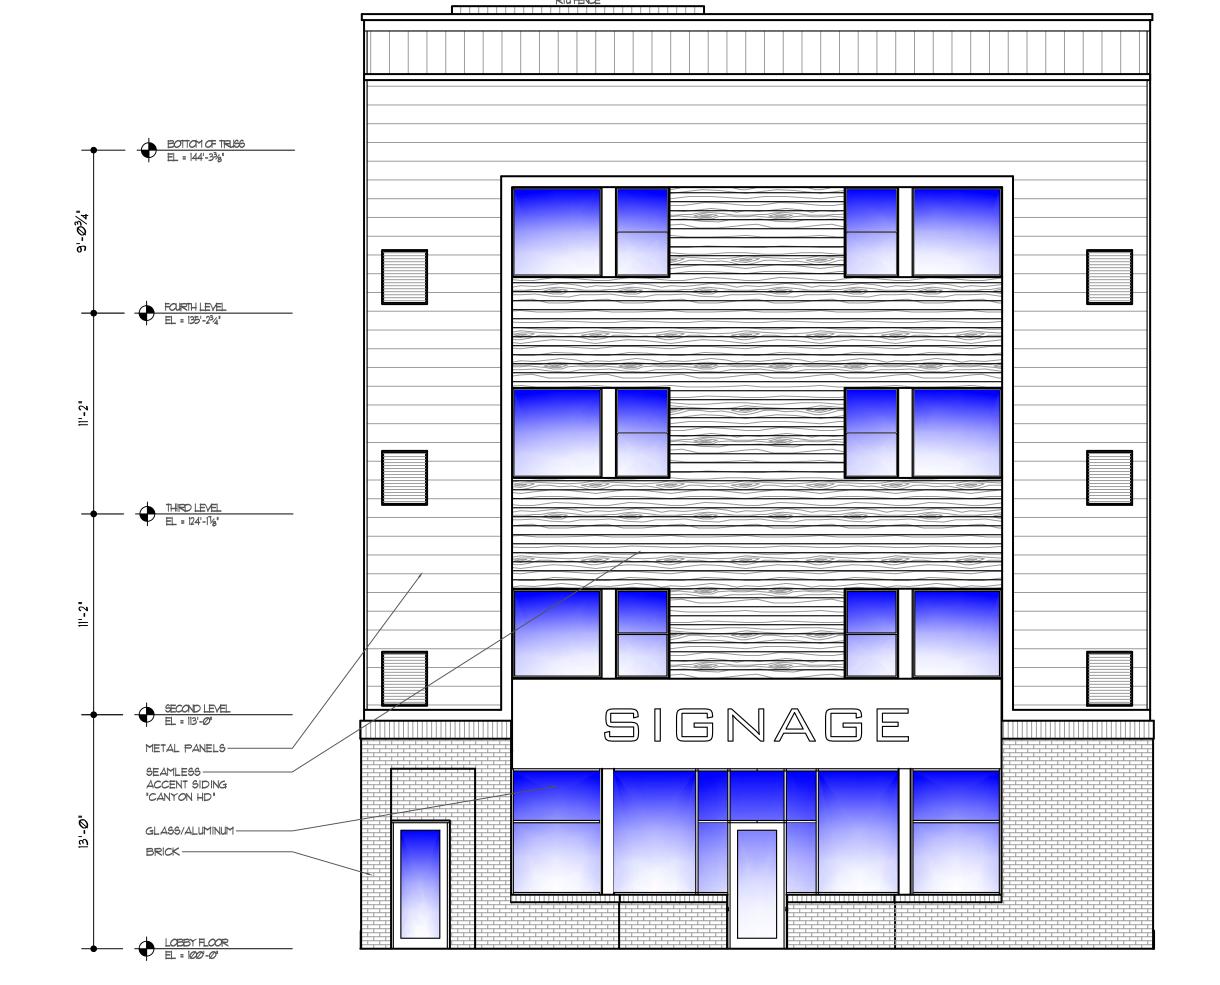



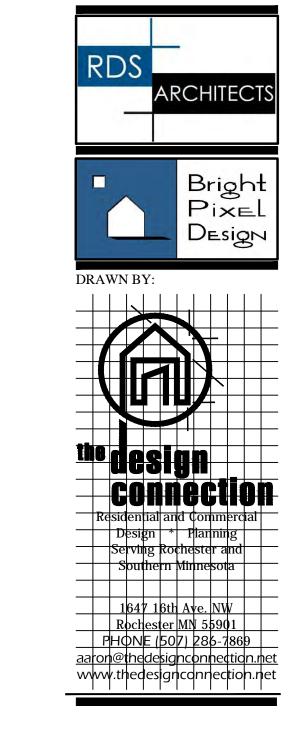

TOTAL ELEVATION AREA - 4343 SF


112 LAKE ST

PROJECT #:	20258
DRAWN BY:	CDB / IJN
CHECKED BY:	MJB / CDB
FINAL DATE:	
	_

PRINTED: Oct 20, 2020

EAST ELEVATIONS

A1.2

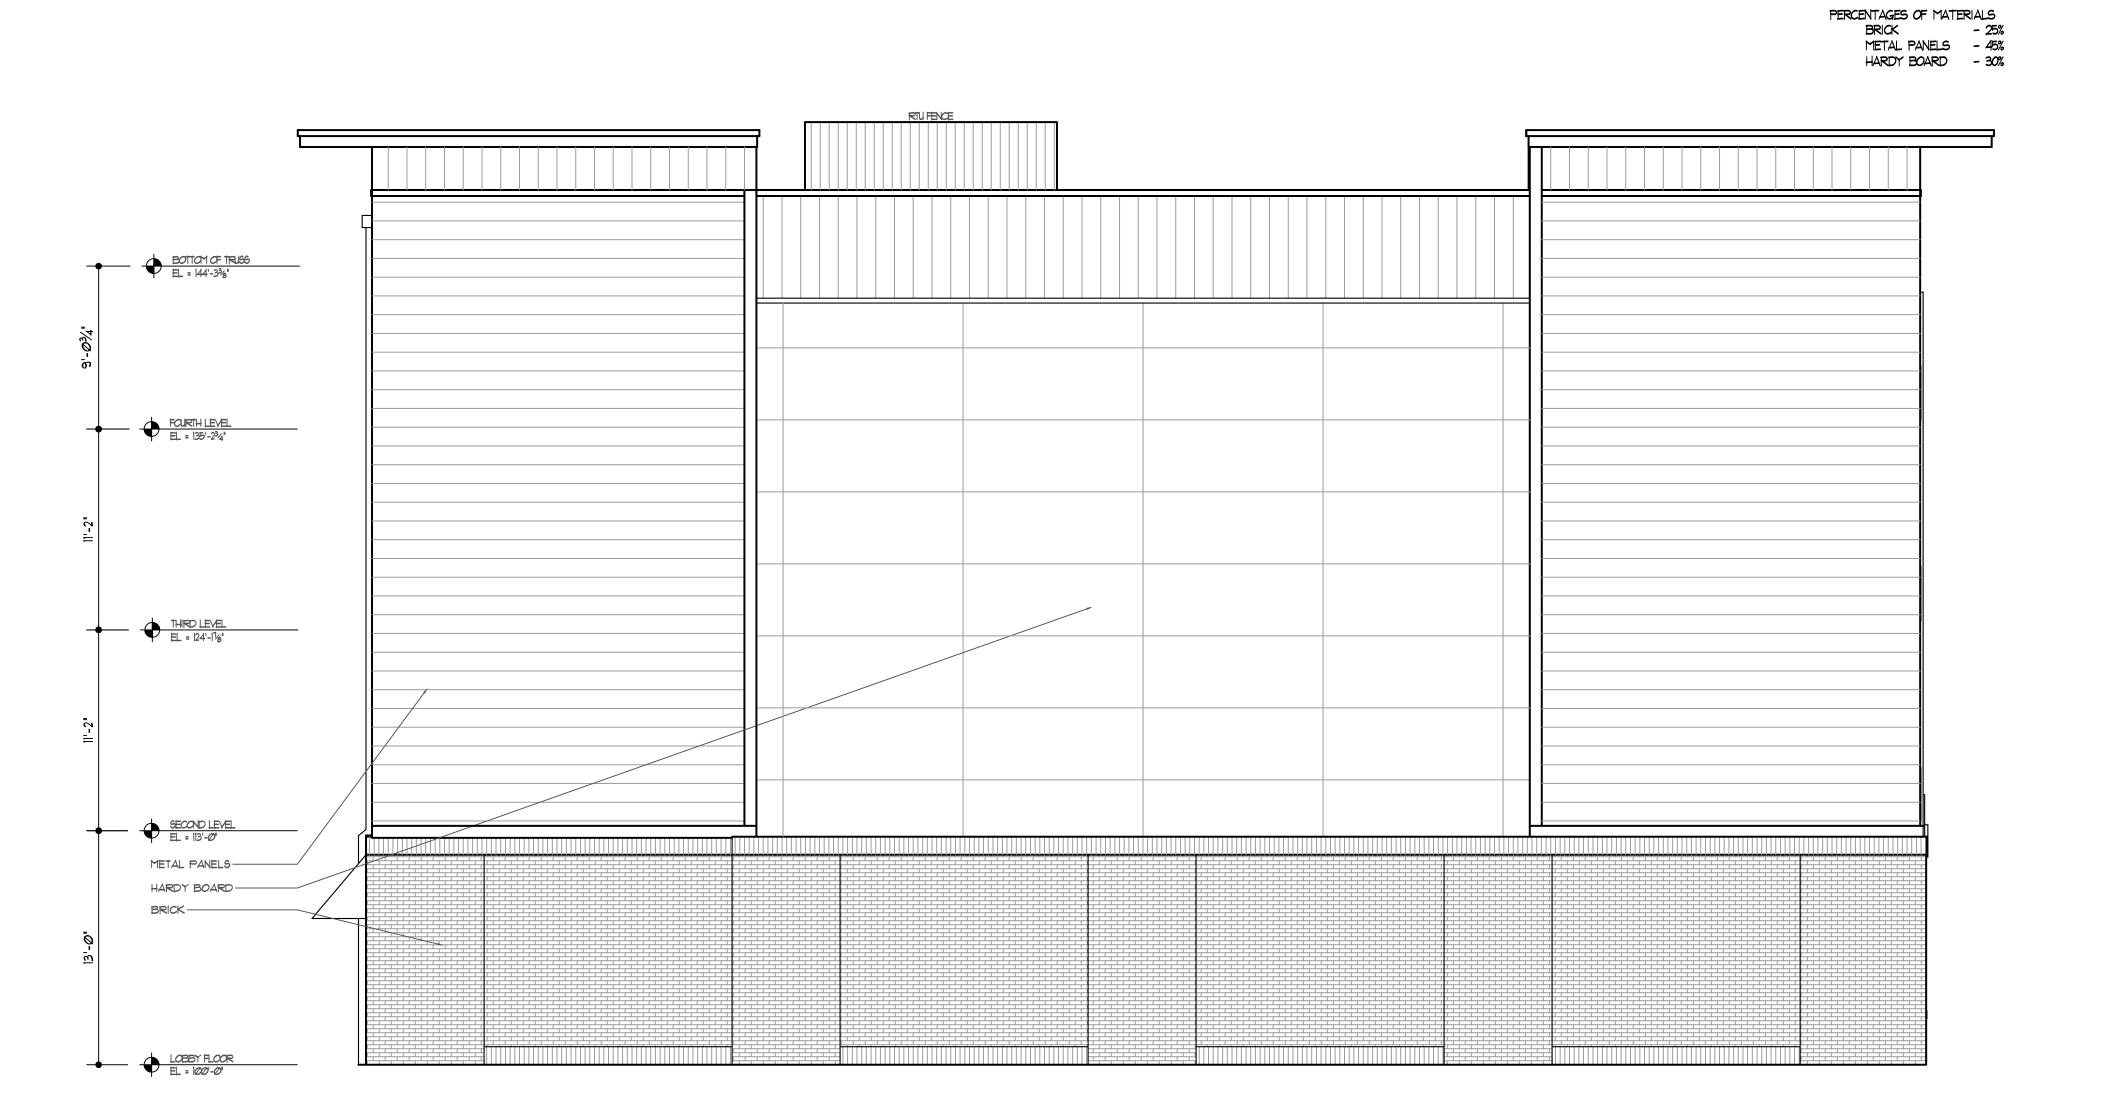

Bright
Pixel
Design

Connection
Residential and commercial
Design * Planning
Serving Rochester and
Southern Minnesota

1647 16th Ave. NW
Rochester MN 55901
PHONE (507) 286-7869
aaron@thedesignconnection.net
www.thedesignconnection.net

TOTAL ELEVATION AREA - 4343 SF


112 LAKE ST

PROJECT #:	202
DRAWN BY:	CDB
CHECKED BY:	MJB / 0
FINAL DATE:	

PRINTED: Oct 20, 2020

west elevations

A 1 3

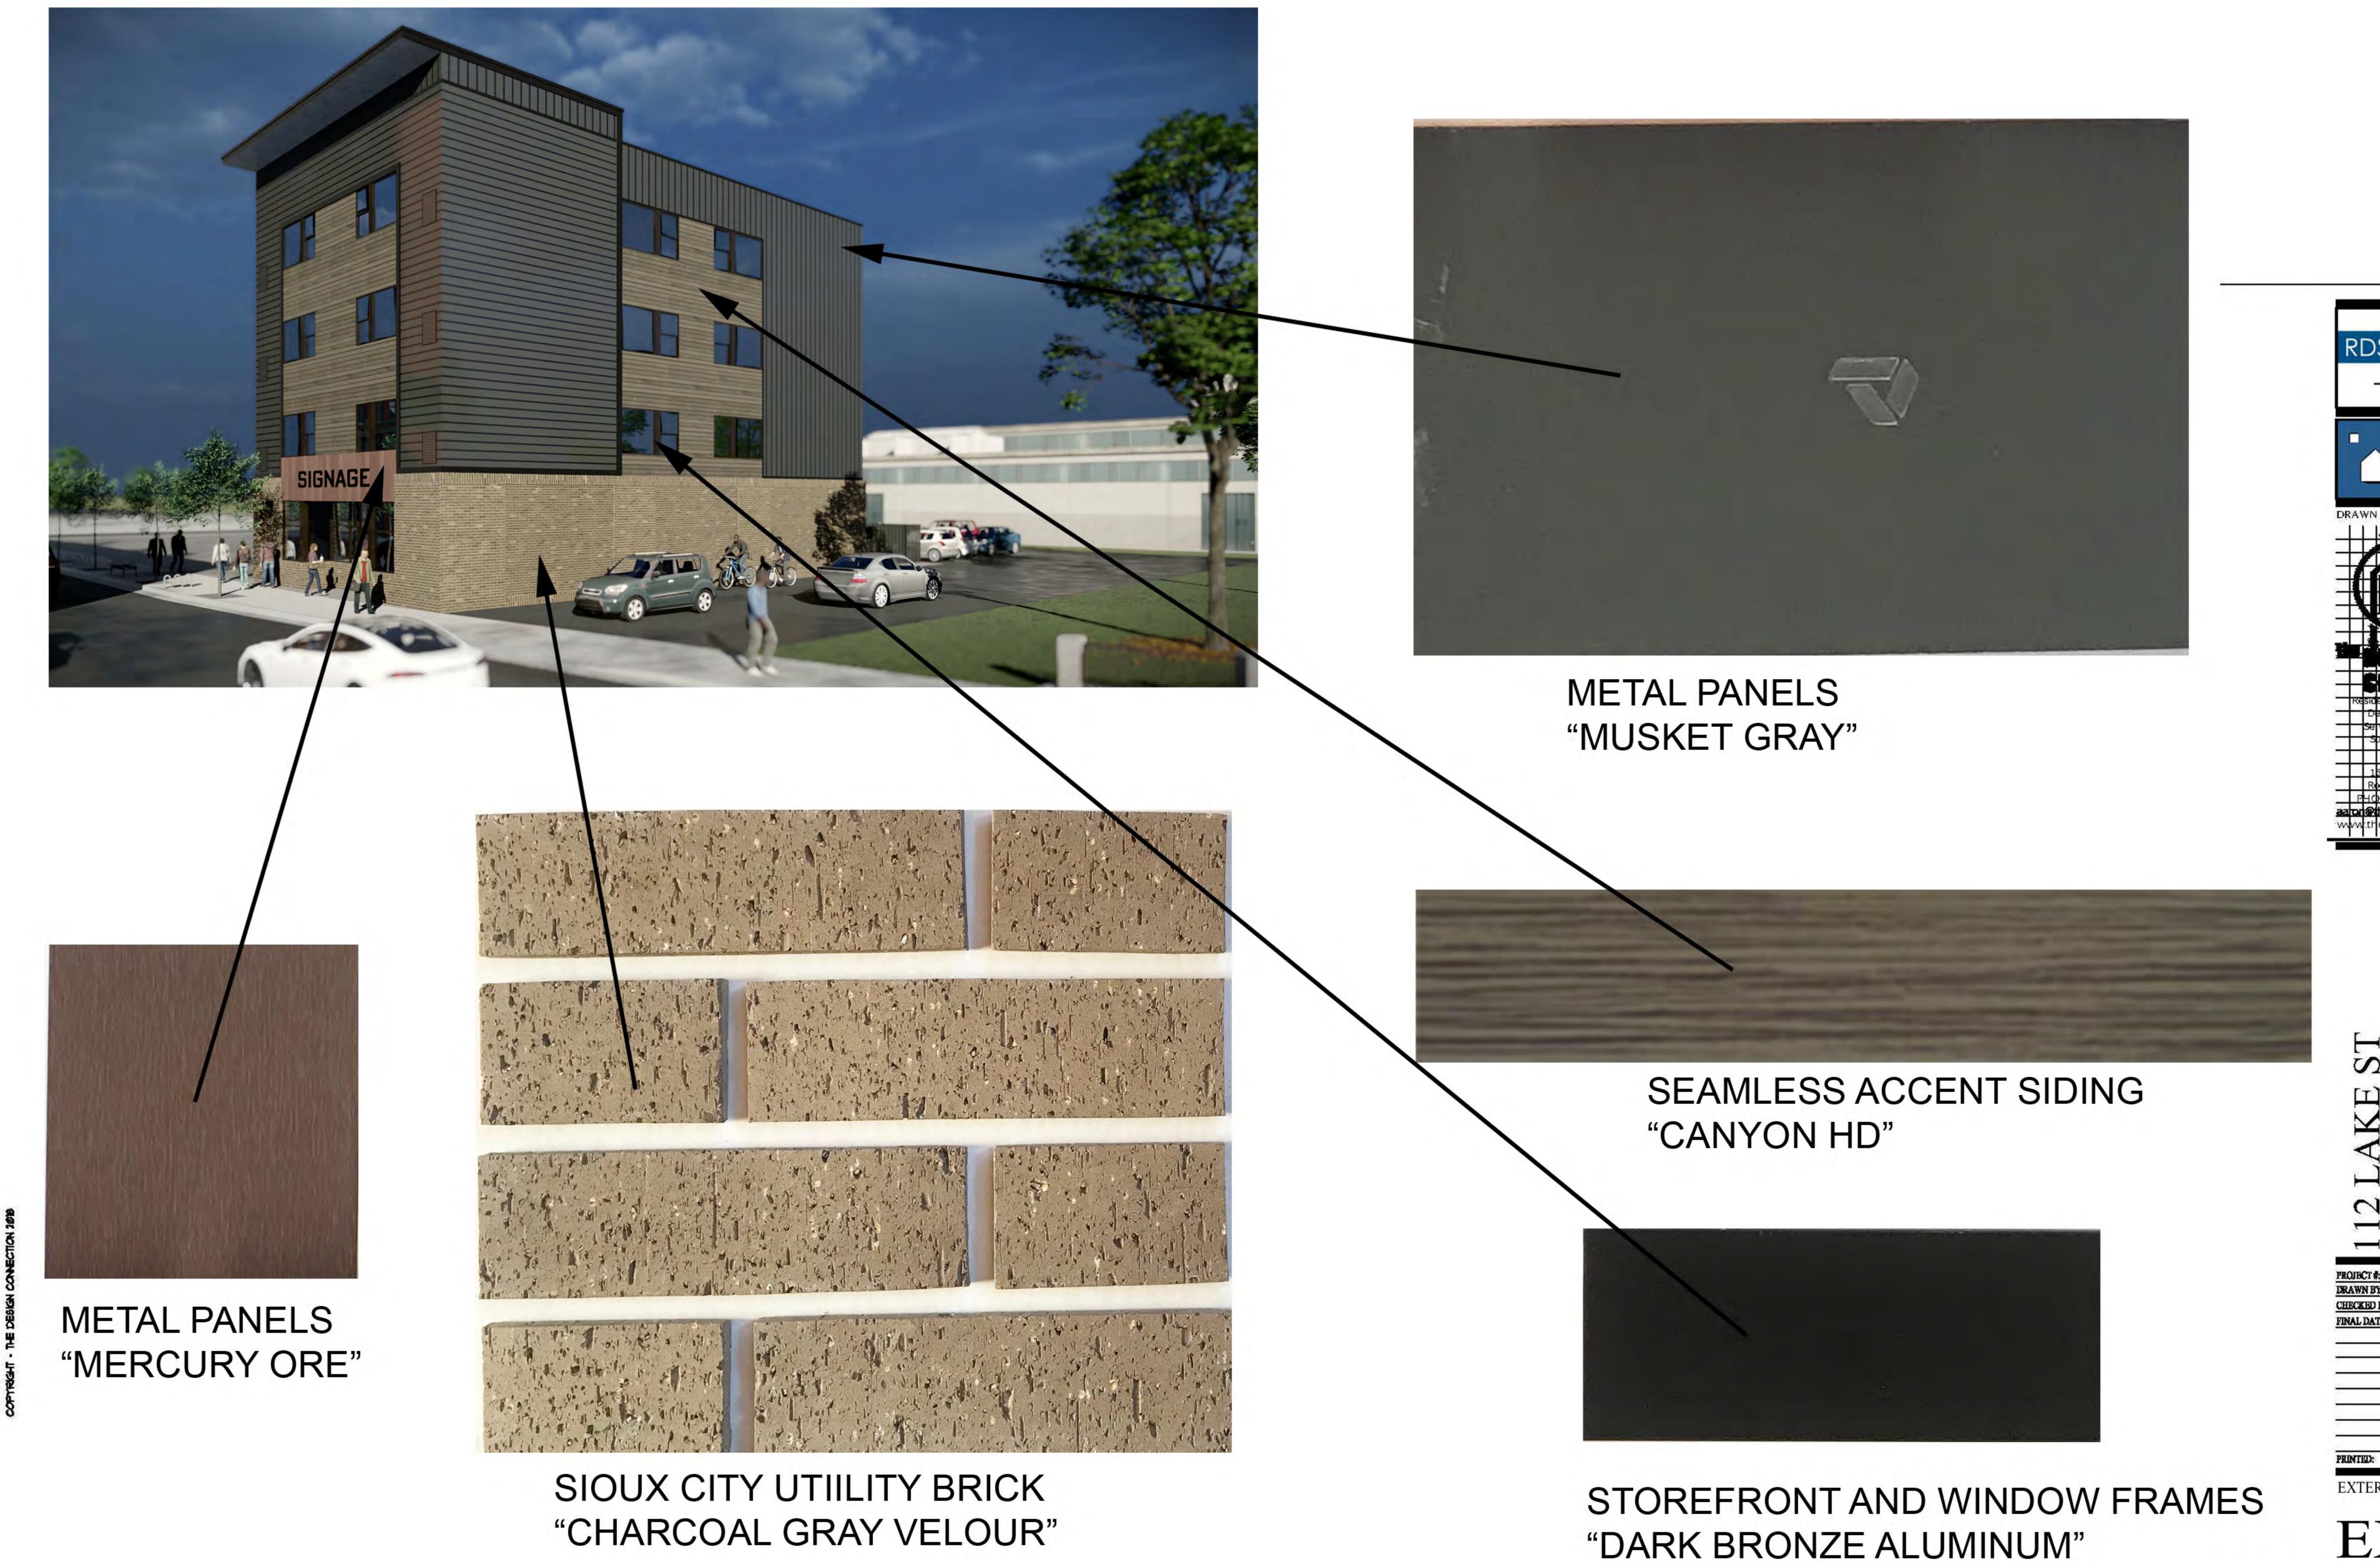


MINNESOTA


T#: 2025
IBY: CDB/I
ED BY: MJB/C

RAWN BY: CDB/D:
HECKED BY: MUB/CD
INAL DATE:

PRINTED: Oct 09, 2020
EXTERIOR MATERIALS

EX1.0

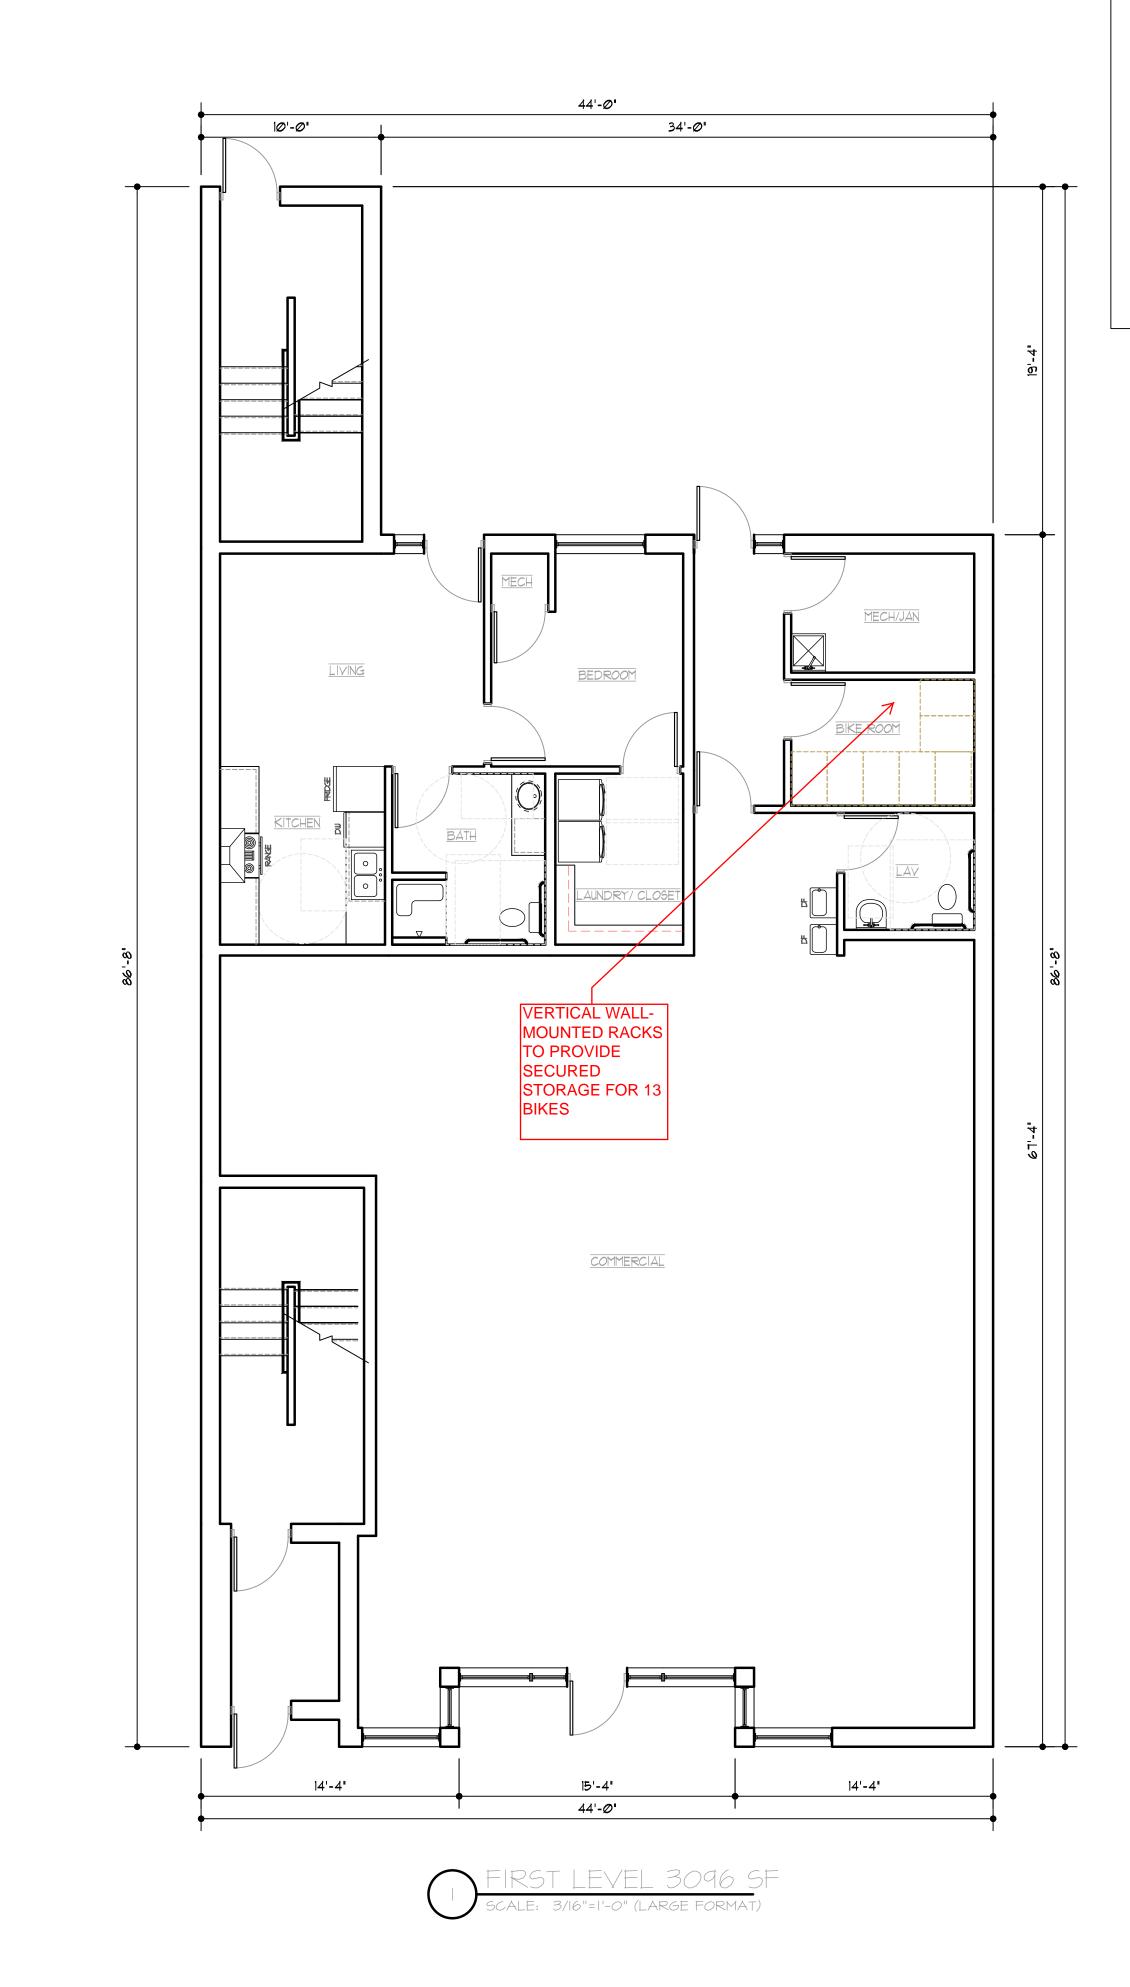

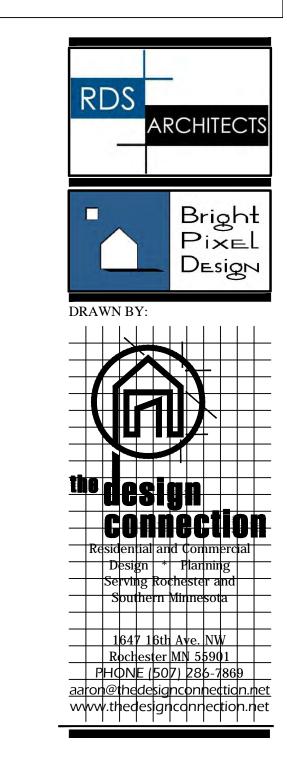


112 LAKE ST

PROJECT #:	202
DRAWN BY:	CDB
CHECKED BY:	MJB /
FINAL DATE:	


FIRST LEVEL FLOOR PLAN

A2.0

Oct 20, 2020

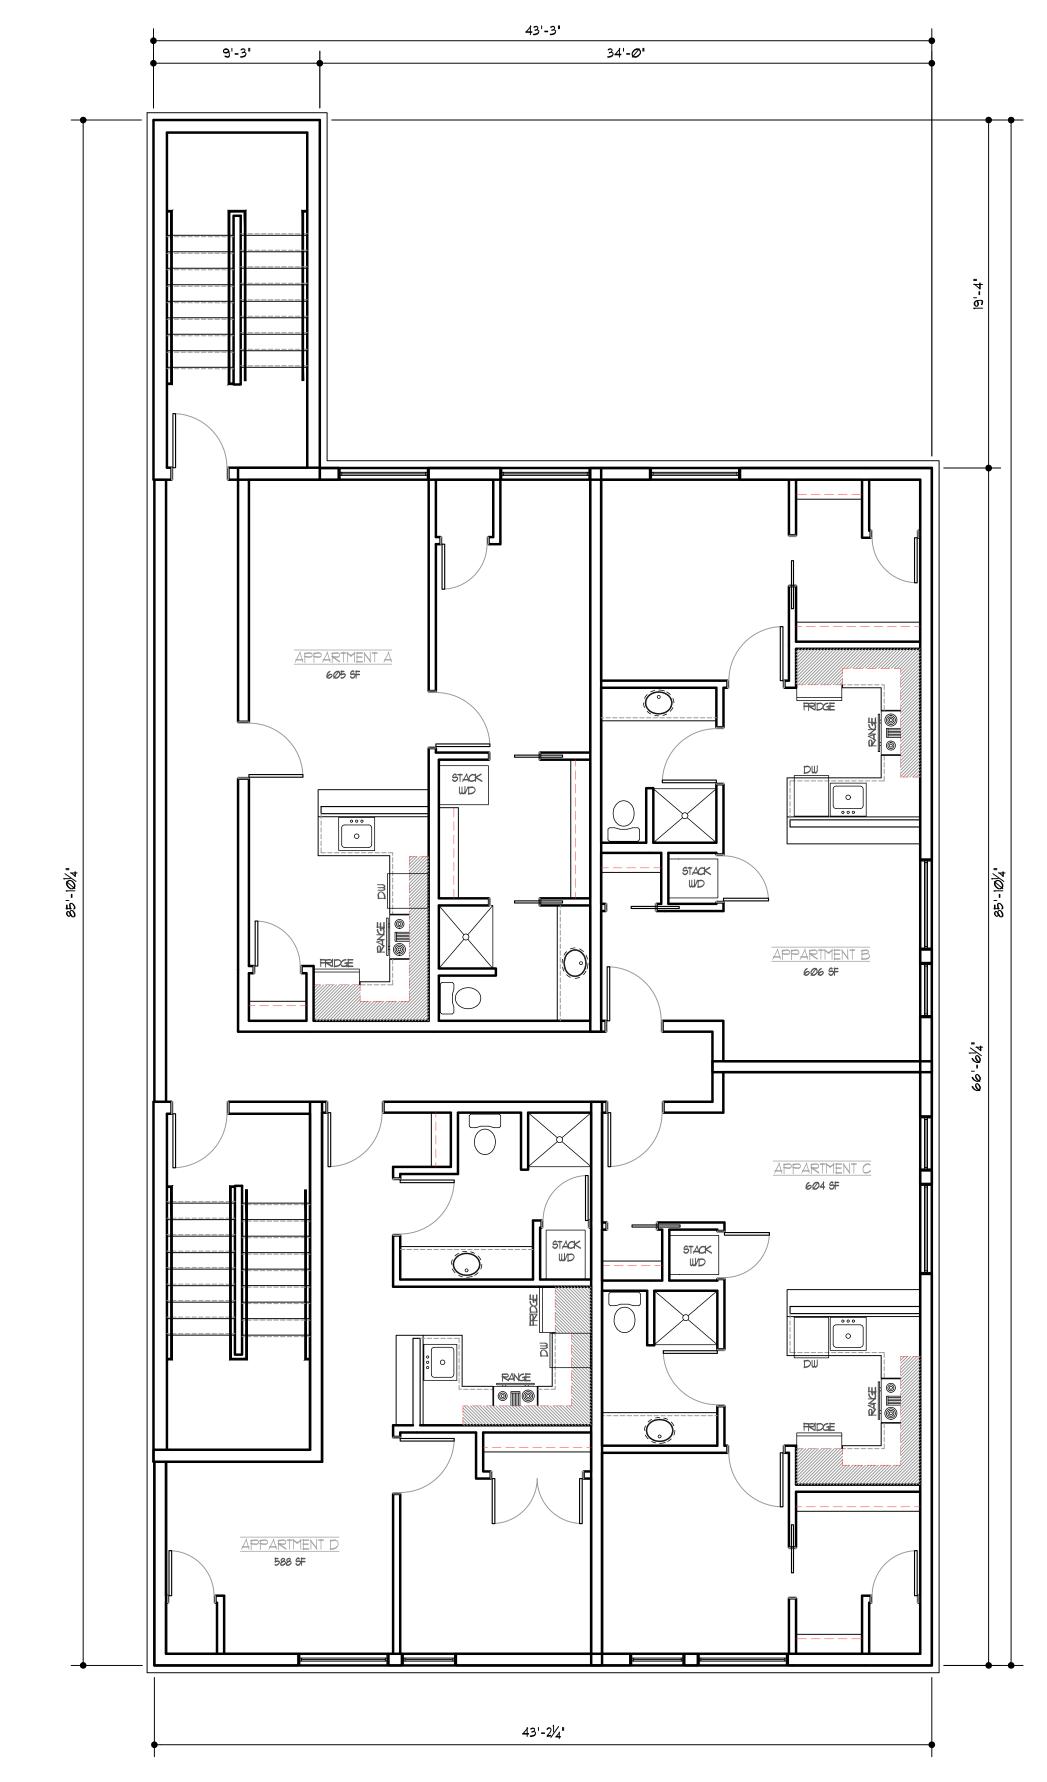

SECOND LEVEL 3053 ST SCALE: 3/16"=1'-0" (LARGE FORMAT)

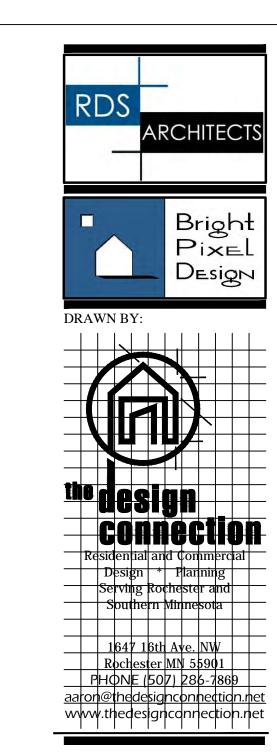


12 LAKE ST

PROJECT #: 20258
DRAWN BY: CDB / IJN
CHECKED BY: MJB / CDB
FINAL DATE:


NTED: Oct 20, 2020
SECOND LEVEL

SECOND LEVEL FLOOR PLAN

A3.0

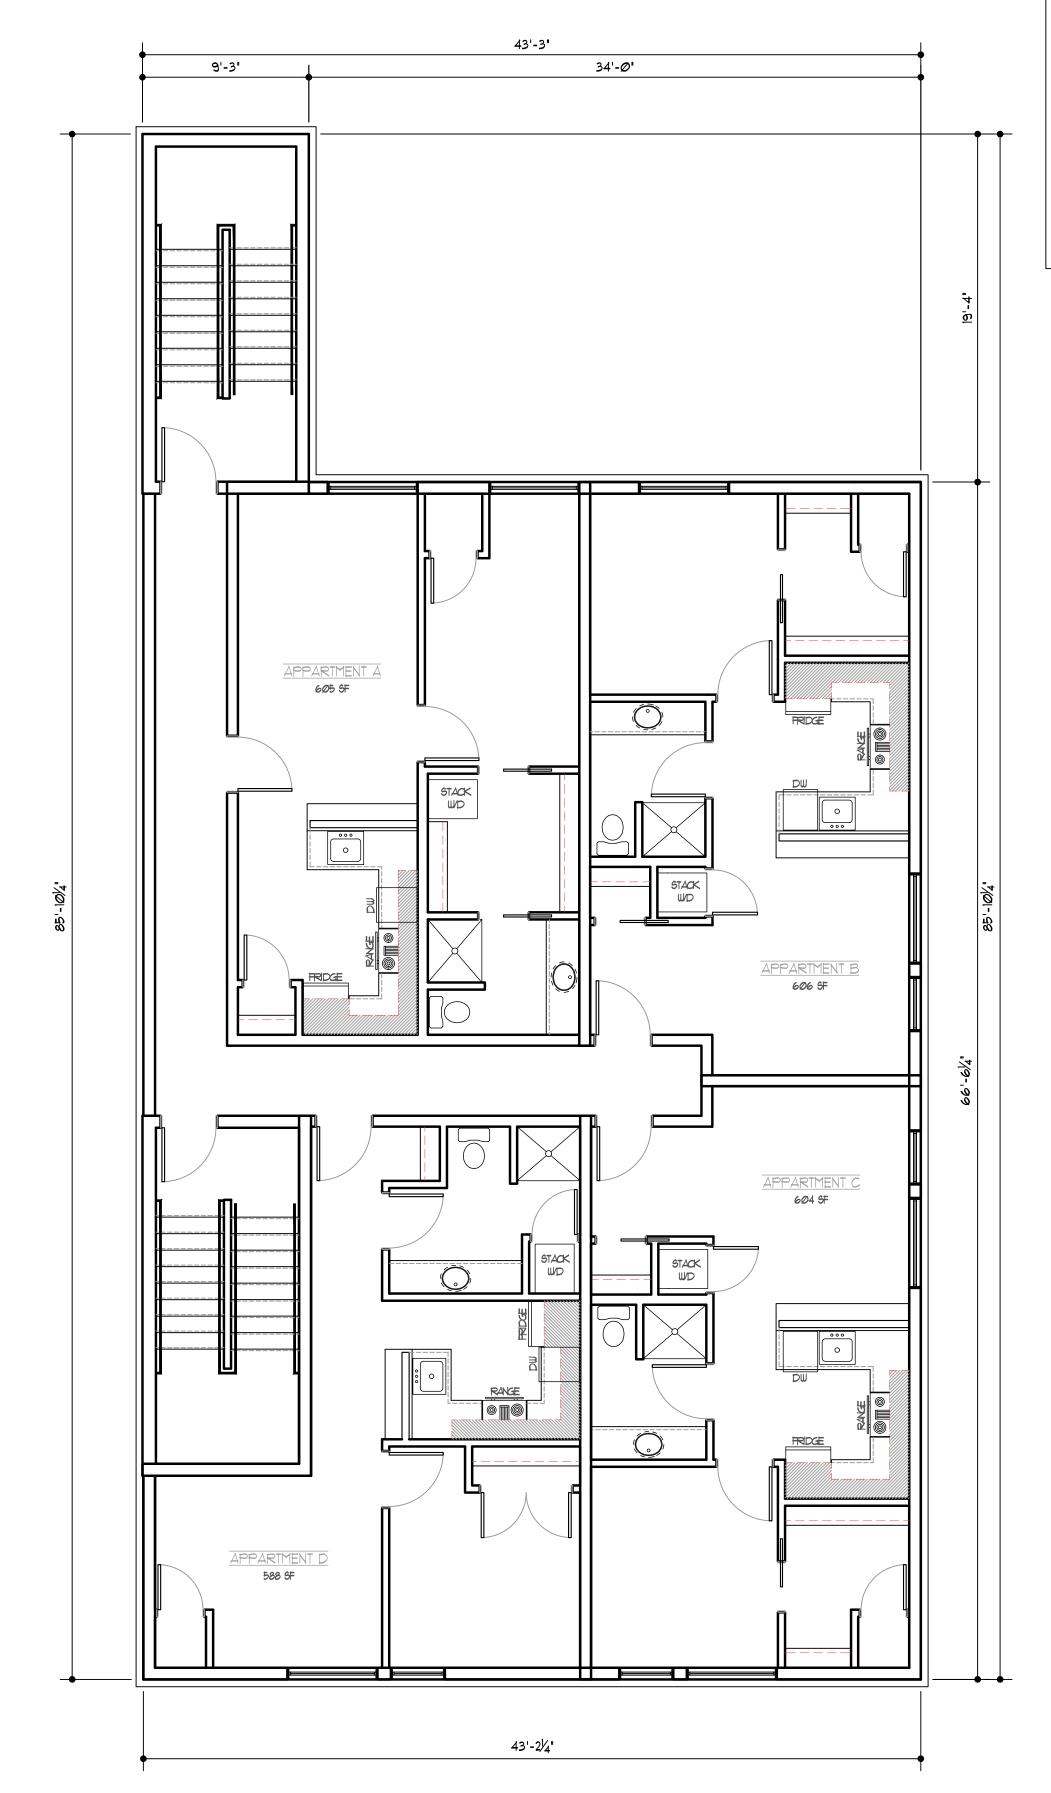

THIRD LEVEL 3053 SF scale: 3/16"=1'-0" (large format)

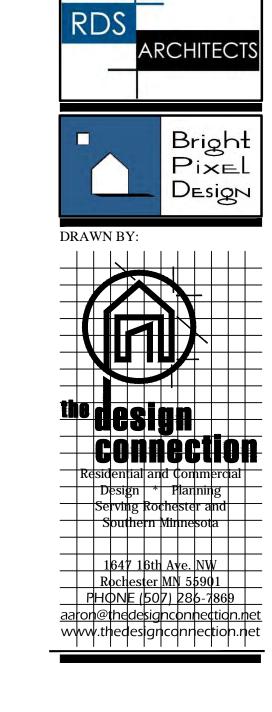



112 LAKE ST

PROJECT #: 20258
DRAWN BY: CDB / IJN
CHECKED BY: MJB / CDB
FINAL DATE:

RINTED: Oct 20, 2020

THIRD LEVEL FLOOR PLAN

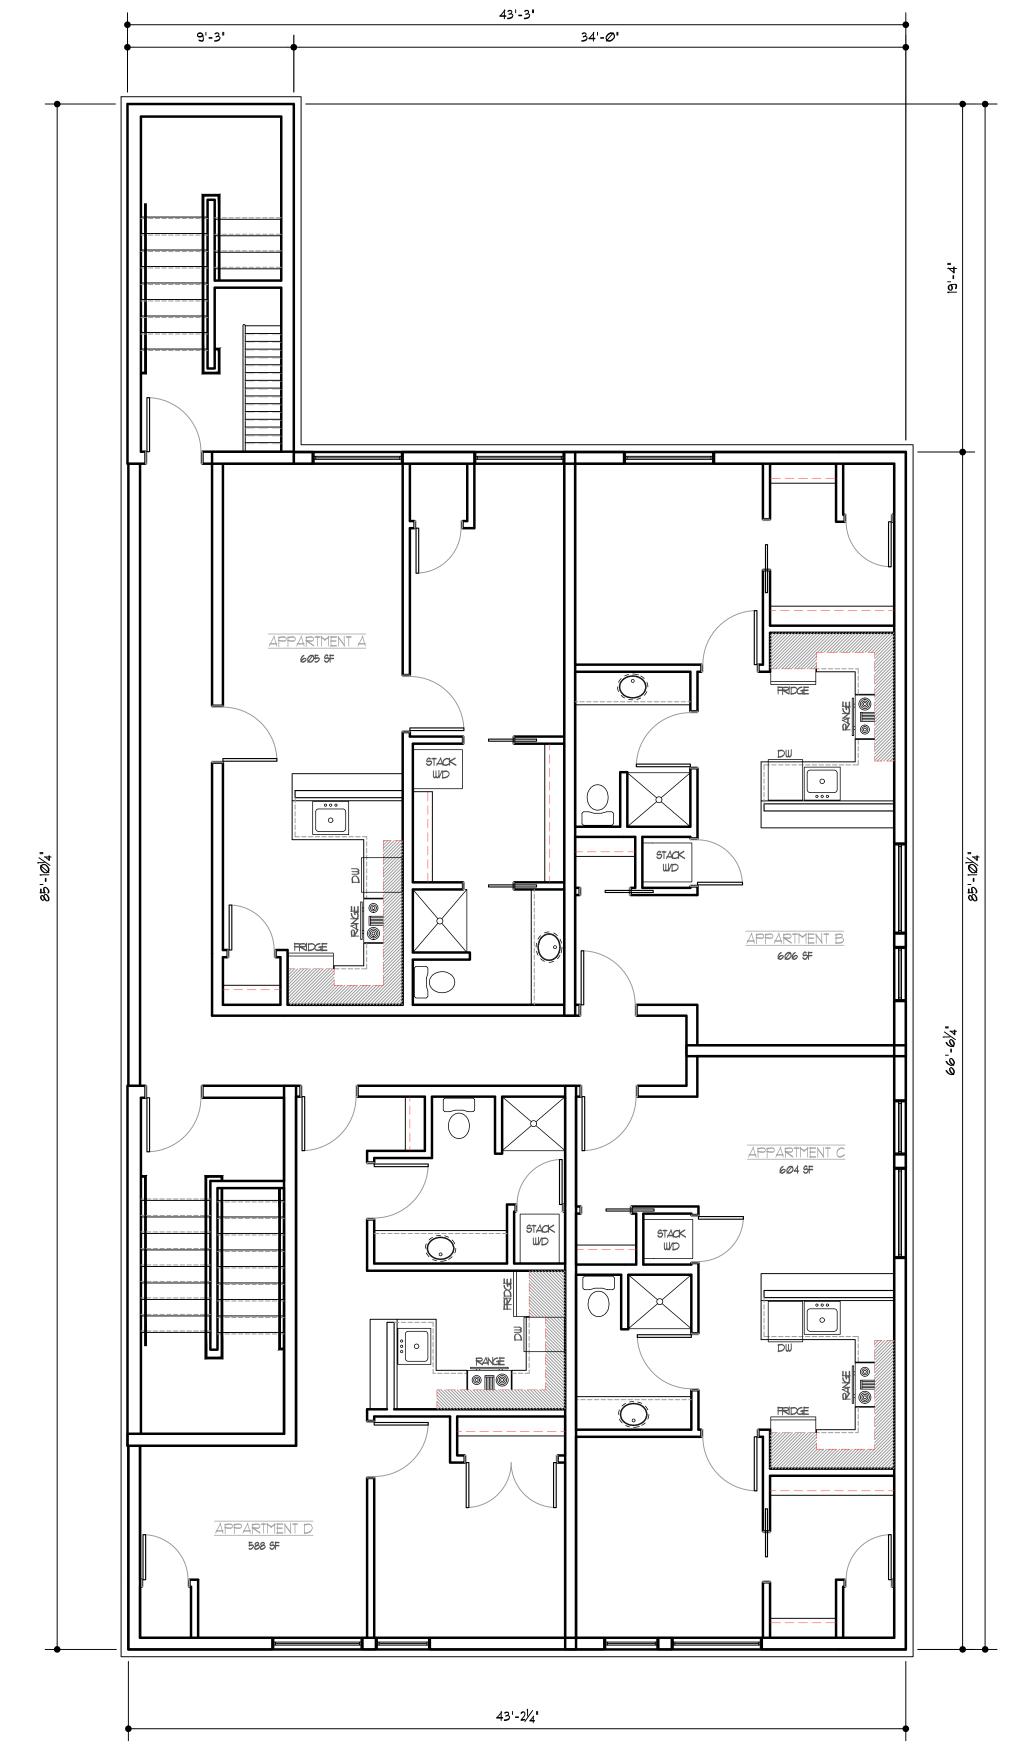


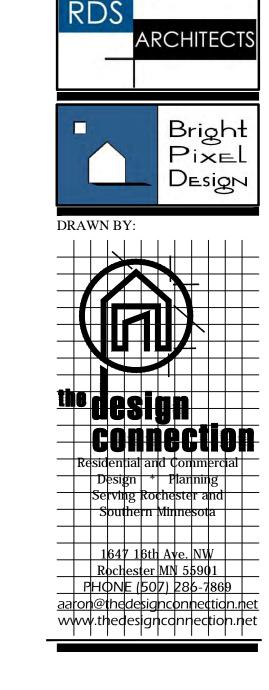


112 LAKE ST

PROJECT #:	202
DRAWN BY:	CDB
CHECKED BY:	MJB /
FINAL DATE:	

Oct 20, 2020 PRINTED: FOURTH LEVEL FLOOR PLAN

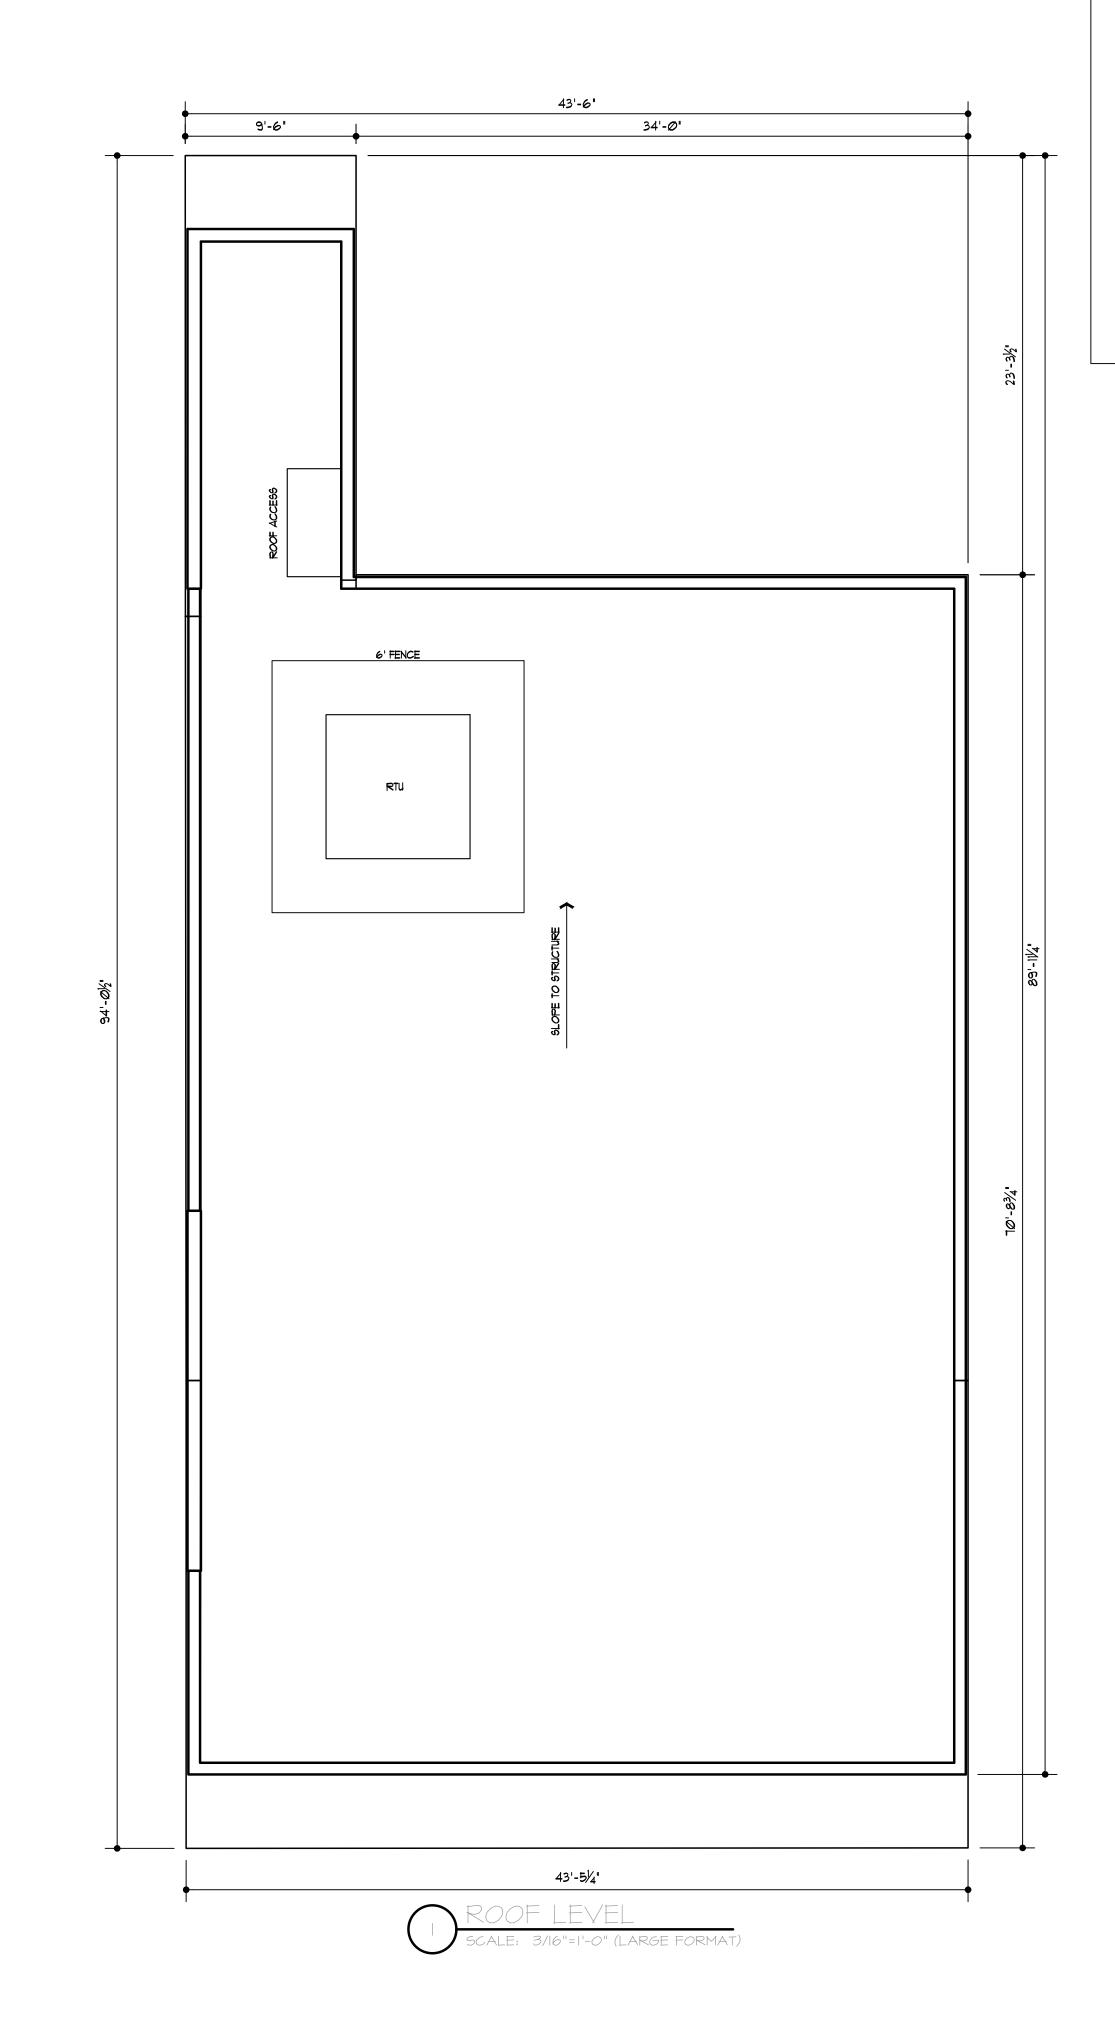

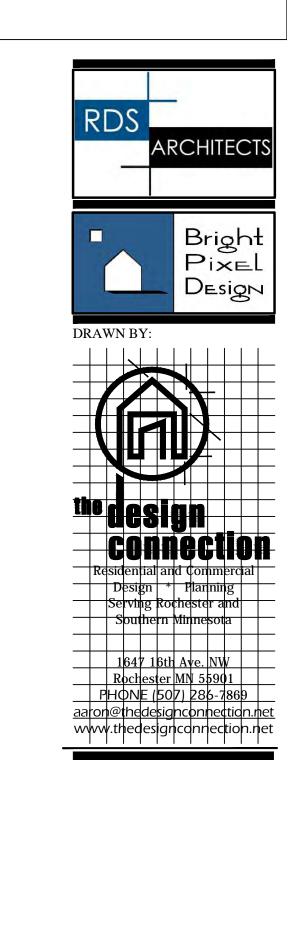

PROJECT #:
DRAWN BY:
CHECKED BY:
FINAL DATE:

A6.0




SOUTHEAST VIEW





NORTHEAST VIEW

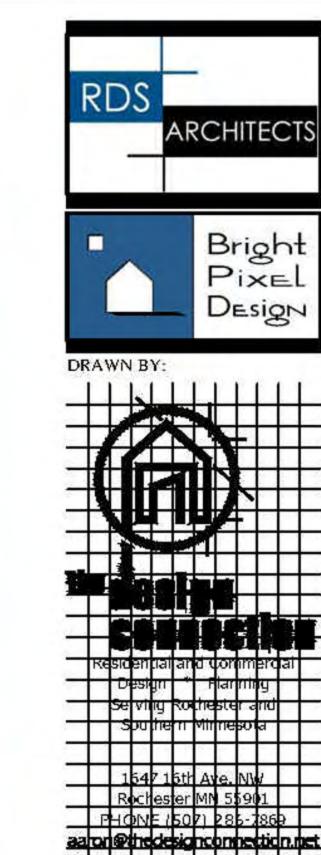

LAKE ST

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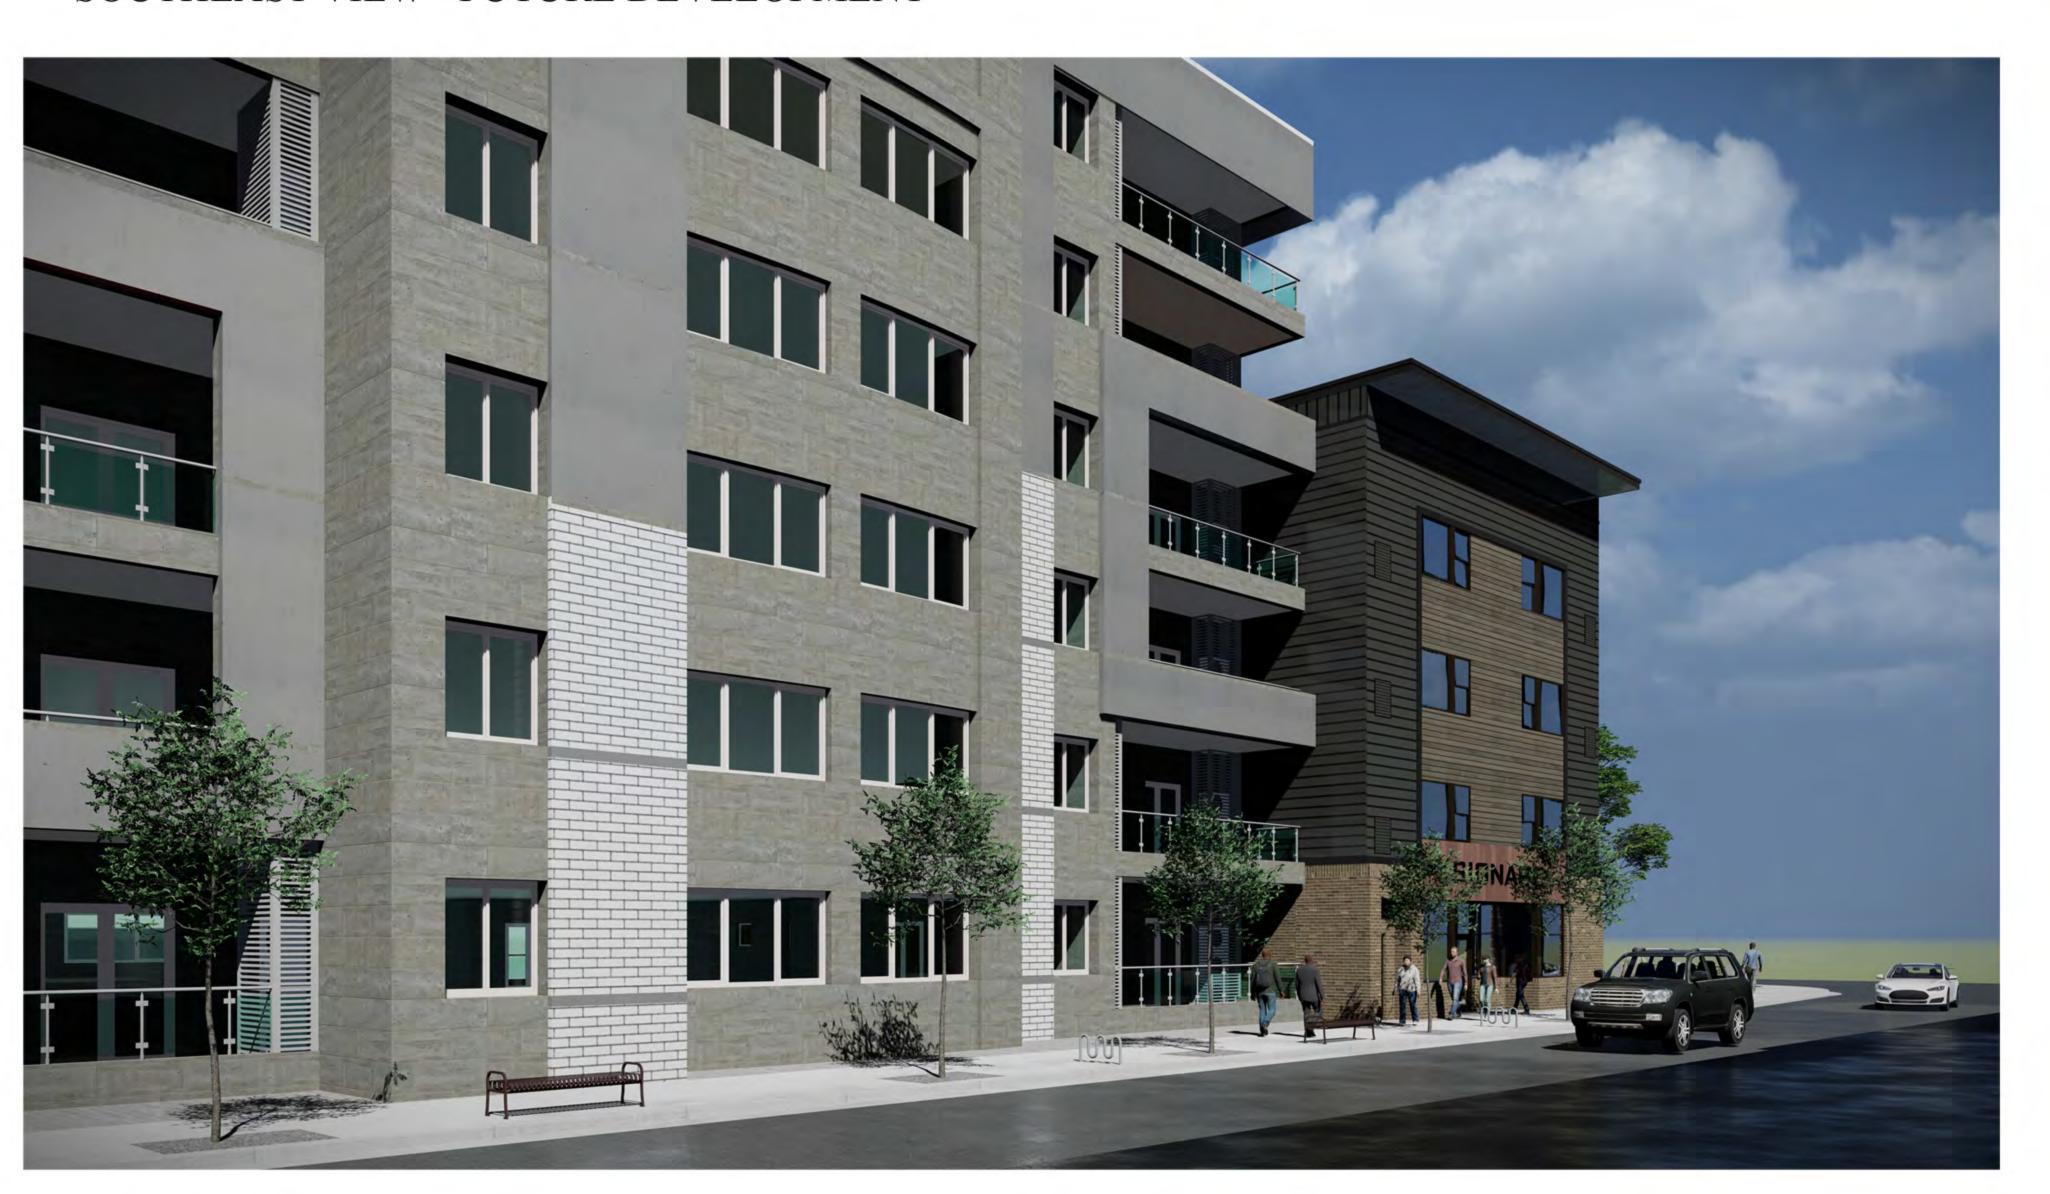
PRINTED: Oct 09, 2020

EXTERIOR RENDERINGS

EX2.0




SOUTHEAST VIEW - FUTURE DEVELOPMENT





NORTHEAST VIEW - FUTURE DEVELOPMENT

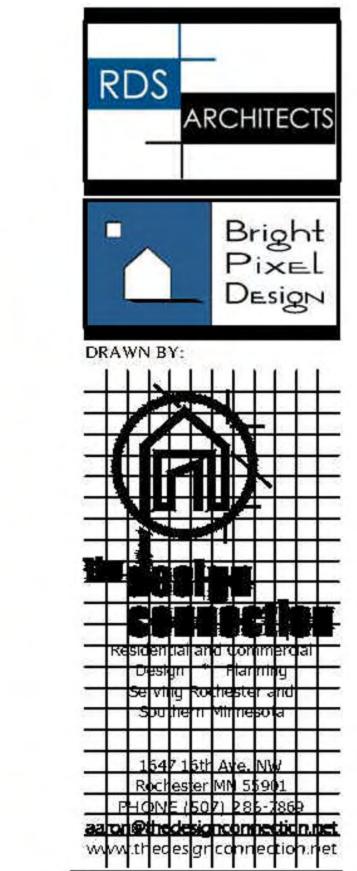

MININEGOTA

PROJECT #:	20258
DRAWN BY:	CDB/DN
CHECKED BY:	MUB / CDB
FINAL DATE:	

D: Oct 09, 202

EXTERIOR RENDERINGS

EX3.0



November 5, 2020

RE: Application for Proposed Development at 112 E Lake St

CC: Andrew Frenz, City of Minneapolis

Commissioners, Minneapolis Planning Commission

Lisa Bender, City Council President

To Whom It May Concern:

I am writing on behalf of the Whittier Alliance Neighborhood Organization to express concerns about the application for a new development at 112 E Lake St, as it is currently proposed. We believe that small but meaningful changes to the building could result in a significantly better project for our community at such a critical time and on such a crucial site.

This development will set the tone for the pending redevelopment of the former Kmart parcel. It will be the entrance to our neighborhood from the under-construction transit hub and multimodal investment by I-35W. The new Lake Street entrance to the Midtown Greenway is less than a block away. This site is the first of several which will need to be rebuilt or redeveloped from the ground up after the unrest in June. We ask that the City, and Mr. Tindall, consider this project in the physical and social context of our community and give it the attention and time that reflects the prominent placement of the building and the redevelopment soon to come. We fully understand that this redevelopment was forced by the unrest, and we want to partner with Mr. Tindall and the City to develop a quality, inviting building that will influence this corridor for decades to come.

We have several specific concerns about the building as proposed, which is insufficiently attentive to the surrounding context or the needs of the neighborhood. As a community, we have consistently advocated for affordability, for a mix of unit types and sizes, and for environmentally sustainable development—all goals in line with the 2040 Comprehensive Plan (particularly Goals 3, 5, 6, 9, and 10). This project does not currently meet those objectives. Any steps to improve the project in these dimensions would be welcomed by the neighborhood and would do much to mitigate our concerns.

Despite these broader and longstanding community concerns, for today we would like to particularly call the City's attention to the design of the building, particularly the eastern facade, and its critical role as an entrance to the neighborhood. The eastern facade of this building faces an undeveloped stretch of land between it and the coming Greenway entrance and the transit hub at I-35W. This wall acts as a prominent entrance to the neighborhood, not a secluded alley, and is likely to remain that way for the foreseeable future.

There are several design changes which could significantly upgrade the experience of this building for the neighborhood and make it more appealing as a future retail space and more attractive to potential tenants. For example:

- Increased glazing, particularly on the ground floor of this highly visual entrance
- Streetscaping, planters, or other "green" features, such as a green wall
- Mural, artistic grating, or other designed element (which could also be featured on the blank wall of the protruding stairwell)

- Integrating the stairwell more holistically in design of the building, rather than creating a second level blank wall
- Upgraded materials, potentially patterned metal siding, brick, or architectural details that add depth to the building's appearance
- Increased and creative lighting to help link transit up with active development
- Inclusion of outdoor space, potentially a patio out back that could be used by a
 restaurant tenant (even at the cost of the parking space) or balconies that would add
 architectural detail and make the project more appealing to tenants

All these recommendations are in line with directives from the city in the Minneapolis 2040 Plan. We have included, as an appendix, a starting list of those policies and action items we find most relevant to the development.

Our goal is not to hinder the project, but to provide Mr. Tindall and the City with an understanding of what this community needs and the support needed to make these changes. If increased costs are a challenge, we would support or even encourage increased density to improve the financial feasibility of the project. We are seeking to find pro bono architectural consulting services which could aid the applicant in exploring creative solutions to raise this building to the standards the site calls for and that we are used to seeing. We would also be willing to help the applicant in seeking and applying for any facade grants or other available resources. We believe this building can anchor a vibrant, revitalized stretch of our Whittier neighborhood.

After an initial meeting with the architect to share the project, the applicant actively chose to withdraw from engagement with the community on this project and declined to give us the opportunity to share more about the surrounding context and work alongside the developer to, together, create a high-quality project. It is unfortunate that the owner chose to not to take an opportunity to learn more about the context and improve the proposal. In accordance with the City's stated goal to: "Actively build the community's capacity to strengthen authentic engagement through neighborhood associations and City advisory committees and to facilitate meaningful resident, business owner and property owner input into City policies, programs and procedures" (Policy 81.a), we ask the Planning Commission to direct the owner and architect to reengage with Whittier Alliance and surrounding neighbors and then resubmit this proposal. We know timelines are tight and our volunteers are available and committed to making this work.

As it stands now, however, we cannot support and must firmly oppose this project. This project fails to deliver on goals of affordability, sustainability, or walkability. It puts a harsh facade up as the welcome sign to Whittier. The City recently spent millions of dollars to acquire the ability to transform this critical node, and MnDOT has spent more than \$150 million on the I-35W Transit/Access project. It would be a tragic waste of that investment to start off this opportunity with lackluster development.

Thank you for the forum to provide our feedback. This project was discussed at a public meeting to which the applicant was invited (but did not attend), and this letter was approved by vote of the Whittier Alliance Board. We are eager to work with the City and Mr. Tindall to develop a dynamic, inviting project at 112 E Lake Street. We can do better.

Sincerely, **Kaley Brown**Executive Director, Whittier Alliance

Appendix of 2040 Comprehensive Plan policies linked to the neighborhood recommendations for this project [not exhaustive]:

- Policy 6.c: "Require windows and window treatments on buildings that allow clear views into and out of the building."
- Policy 6.d: "Ensure that buildings incorporate design elements that eliminate long stretches of blank, inactive exterior walls through provision of windows, multiple entrance doors, green walls, and architectural details."
- Policy 6.y: "Encourage building designs that reflect the unique site and context where they lie within the city."
- Policy 7.c: "Require developers to implement public realm improvements called for in the citywide framework in conjunction with approvals for building construction and site modification."
- Policy 7.f: "Encourage and identify opportunities to integrate green roofs, living walls, and porous pavement into development, acknowledging that these practices are not meant to be a substitute for ground-level landscaping of sites as landscaping provides both a natural amenity and aesthetic beauty to the urban landscape."
- Policy 7.g: "Encourage boulevard landscaping and improvements, in accordance with applicable City policies and regulations.
- Policy 9.d: "Integrate exterior building lighting design to attune with building designs and landscaping."
- Policy 9.f: "Encourage additional pedestrian-scale, exterior lighting in areas with high pedestrian traffic such as transit station areas and Goods and Services corridors."
- Policy 58.c: "Support community efforts to brand and market retail districts and corridors as cultural districts and cultural corridors."
- Policy 80.h: "Focus active uses on the ground floor of buildings along main pedestrian routes leading to and facing METRO stations."